

west virginia department of environmental protection

Office of Oil and Gas 601 57th Street, S.E. Charleston, WV 25304 (304) 926-0450 fax: (304) 926-0452

Austin Caperton, Cabinet Secretary www.dep.wv.gov

Monday, December 9, 2019
WELL WORK PERMIT
Coal Bed Methane Well / Plugging

CNX GAS COMPANY LLC 1000 CONSOL ENERGY DR

CANONSBURG, PA 15370

Re: Permit approval for L-55 47-061-01449-00-00

This well work permit is evidence of permission granted to perform the specified well work at the location described on the attached pages and located on the attached plat, subject to the provisions of Chapter 22 of the West Virginia Code of 1931, as amended, and all rules and regulations promulgated thereunder, and to any additional specific conditions and provisions outlined in the pages attached hereto. Notification shall be given by the operator to the Oil and Gas Inspector at least 24 hours prior to the construction of roads, locations, and/or pits for any permitted work. In addition, the well operator shall notify the same inspector 24 hours before any actual well work is commenced and prior to running and cementing casing. Spills or emergency discharges must be promptly reported by the operator to 1-800-642-3074 and to the Oil and Gas Inspector.

Please be advised that form WR-35, Well Operators Report of Well Work is to be submitted to this office within 90 days of completion of permitted well work, as should form WR-34 Discharge Monitoring Report within 30 days of discharge of pits, if applicable. Failure to abide by all statutory and regulatory provisions governing all duties and operations hereunder may result in suspension or revocation of this permit and, in addition, may result in civil and/or criminal penalties being imposed upon the operators.

Per 35 CSR 4-5.2.g this permit will expire in two (2) years from the issue date unless permitted well work is commenced. If there are any questions, please feel free to contact me at (304) 926-0450.

James A. Martin

Chief

Operator's Well Number: L-55

Farm Name: RANGE RUN RETREAT

U.S. WELL NUMBER: 47-061-01449-00-00

Coal Bed Methane Well Plugging

Date Issued: 12/9/2019

PERMIT CONDITIONS

West Virginia Code § 22-6-11 allows the Office of Oil and Gas to place specific conditions upon this permit. Permit conditions have the same effect as law. Failure to adhere to the specified permit conditions may result in enforcement action.

CONDITIONS

- 1. All pits must be lined with a minimum of 20 mil thickness synthetic liner.
- 2. In the event of an accident or explosion causing loss of life or serious personal injury in or about the well or while working on the well, the well operator or its contractor shall give notice, stating the particulars of the accident or explosion, to the oil and gas inspector and the Chief within twenty-four (24) hours.
- 3. Well work activities shall not constitute a hazard to the safety of persons.

1) Date 11/18	, 2019
2) Operator's	
Well No. L-55	
3) API Well No.	47-061 - 01449

STATE OF WEST VIRGINIA DEPARTMENT OF ENVIRONMENTAL PROTECTION OFFICE OF OIL AND GAS

APPLICATION FOR A PERMIT TO PLUG AND ABANDON

4)	Well Type: Oil/ Gas × / Liquid	d injection / Waste disposal /
-,		derground storage) Deep/ Shallow_x
5)	Location: Elevation 1338	Watershed Range Run
	District Battelle	County Monogalia Quadrangle Mannington
<i>C</i> \	CNX Gas Company II C	Anthony Kendziora
6)	Well Operator Address Address Address	7) Designated Agent Anthony Kendziora Address 1000 Consol Energy Dr
	Address 1000 Consol Energy Dr. Canonsburg, PA 15317	Canonsburg PA 15317
	Canonically, 177 10017	- Canonissaig 174 16617
8)	Oil and Gas Inspector to be notified	9)Plugging Contractor
0,	Name Gayne Knitowski	Name Coastal Drilling East LLC
	Address P.O. Box 108	Address 70 Gums springs road
	Gormania, WV 26720	Morgantown WV 26508
		RECEIVED Office of Oil and Gas
		NOV 2 1 2019
		WV Department of Environmental Protection
	fication must be given to the district of can commence.	il and gas inspector 24 hours before permitte
Nork	order approved by inspector	Kn(m) Date 1/19/2019

Well: L-55 (Bowsher)

API#: 47-061-01449

District: Battelle

County: Monongalia

Elevation: 1339' (E&S Plans)

L-55 Proposed Plugging and Abandonment Procedure

- 1. Run in and tag TD (~980′-1020′) with wireline or small sandline tools. Confirm TD is inside slotted casing. (Make call to CNX if tagging high to come up with game plan or once has been found)
- 2. Once TD has been reached in slotted casing proceed to fill slotted casing with pea gravel to (680'-720') (1 ton= ~20 Cu. Ft. fill)
- 3. Once pea gravel has been placed in slotted liner verify top of gravel is at or above top of slotted casing
- 4. Once top of pea gravel has been verified TIH with tubing and prepare to cement
- 5. Place 50' cement plug on top of pea gravel
- 6. TOOH with cement string

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Office of Oil and Gas

7. Rig up wireline and tag 50' cement plug

NOV 2 1 2019

8. TOOH and prepare to run Bond Log on 5 ½" casing

WV Department of Environmental Protection


- Run Bond Log from top of cement plug to surface to verify casing is cemented to surface. If cement top if found to not be at surface notify CNX and prepare to pull uncemented casing
- 10. If cement on 5 ½" is at surface or once uncemented has been pulled prepare to cement well to surface
- 11. TIH with work string to top of cement plug and cement well to surface
- 12. TOOH w/ work string and top off well with cement
- 13. Install 6"x14' monument (10' below grade, 4' above grade). Monument must contain API#, Well Name, Company Name and Date Plugged

Note: All cement will be Class A. All spacers will be 6% gel

13/16/2019

Bowsher L-55

Battelle District, Monongalia WV
Original Completion:?
API #47-061-01449
Elevation = 1339' (From E&S Plans)

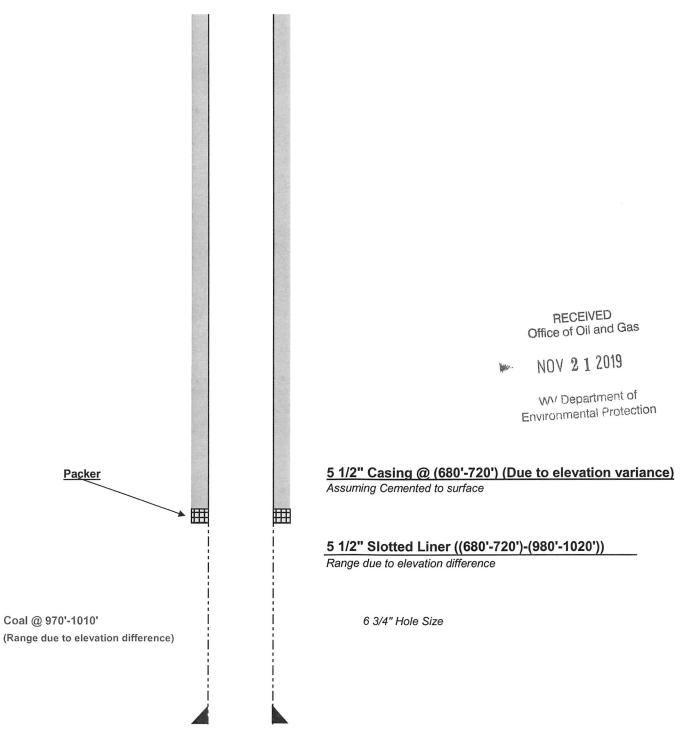

TD @ (980' to 1020') (Due to elevation difference) WR-35

DATE: August 4, 2004 API#: 47-6101449

State of West Virginia Department of Environmental Protection Office of Oil and Gas

Office	of Oil and G	l Protection as				
Well Operator	's Report of V	Vell Work				,
Farm Name: Bowsher, Robert		Operate	or Well 1	No.: <u>L-55</u>		-
LOCATION: Elevation: 1296	·	Quadra	ngle: _	Mannington	1	-
District: Battelle		County	: Moi	nongalia		_
Latitude: 785.2 Feet South of Longitude: 2585 Feet West of		Deg. 3		_	30 Sec. 00 Sec.	
Longitude. 2363 Feet west of	- 80	Deg. <u>2</u>	<u> </u>	Min.	oo sec.	i
Company: CNX Gas Company LLC (North)						i
	Casing &	Used Drilli		Left In Well		
Address: 1800 Washington Road	Tubing	Driiu	ing		Up Cu. Ft.	-
Pittsburgh, PA 15241						- i
Agent: Edwin Merrifield					1	-
Inspector: Randal Mick						-
Date Permit Issued: 9/17/2002						_
Date Well Work Commenced: Existing Borehole						
Date Well Work Completed: Converted to well						_
Verbal Plugging:						
Date Permission granted on:						-
Rotary Cable Rig						-
Total Depth (feet): 980					 	ECEIVED
Fresh Water Depth (ft.):					Office H	of Oil and Gas
Sale Water Dough (ft.)		-			Office	OI OII and gas
Salt Water Depth (ft.):						0040
Is coal being mined in area (N/Y)? No		 			1 № N0 V	2 1 2019!
Coal Depths (ft.): 970						•
					14/1/	Department of
						mental Protection
OPEN FLOW DATA					Ellalion	mental i s
	_					
Producing formation Pittsburgh Coal Seam		e depth (ft)			در	- 1
Gas: Initial open flow 114 MCF/d Final open flow 114 MCF/d	Oil: Initial of Final open f		0	Bbl.		
Time of open flow between initial and final tests		TOM.	Hours		·u	
Static rock pressure 1 psig (surface pressure 1		•	Hours			
kog (c kog	_					
Second producing formation None	Pay zo	ne depth (ft)			
Gas: Initial open flow MCF/d	Oil: Initial o	pen flow		Bbl	<u>/d</u>	
Final open flow MCF/d	Final open f	llow		Вы	/d	
Time of open flow between initial and final tests		• • • • • • • • • • • • • • • • • • • •	_ Hours			3
Static rock pressure psig (surface press	sure) after _		Hours			õ
\\\\\\\\\\\\\\\\\\\\\\\\\\\\\\\\\\\\\\						M0 N0
NOTE: ON BACK OF THIS FORM PUT THE I						V
INTERVALS, FRACTURING OR STIMULATIN LOG WHICH IS A SYSTEMATIC DETAILED	GEOLOGIC	AL DECOR	D OF A	J. 2). THE V	CLL	_
INCLUDING COAL ENCOUNTERED BY THE	WELL BUDGIC	nl recuk	U UF A	TT LAKWA	RECEIVED ffice of Oil & Gas	7 4
N	·· LLLDVKE.	•		1	Office of Chief	bhhi
Signed: June Carro	_					1 2
By: Voseph P. Aman				A	UG-0-9-2004 -	1
D . 4 . 4 0004				1		7

FORM WW-5B (8/1998)

Page 1 of 3 47-0/449C 061-01449C

STATE OF WEST VIRGINIA

DEPARTMENT OF ENVIRONMENTAL PROTECTION, OFFICE OF OIL AND GAS .. COALBED METHANE PERMIT APPLICATION

		OSTESSED WE THANK PERMIT APPLICATION		
1) W	ell Operat	or: CNX Gas Company, LLC (North) 2) Well Name St. Leo Gob We	1 45 7 ell No. L-55	
		Well Number L-55 4) Elevation 1296'		
5) W	ell Type:	(a) Oil/ or Gas/ (b) If Gas: ProductionX/ Underground Storage/ CF Deep/ ShallowX/	BM/	
6) Pro	posed Ta	rget Formation(s): Pittsburgh Coal Seam Mine Methane		
		fal Depth: 980 feet	RECEIV Office of Oil	& Gas
δ) Ap	proximate	Fresh Water Strata Depths: Not known	Permitti	
9) App	proximate	Salt Water Depths: Not known	AUG 2 9	
10)	Appr	oximate Coal Seam Depths: Pitttburgh @ 970'	WV Deparin Environmental I	nent of Protection
11)	Does	Land Contain Coal Seams Tributary to Active Mines? Yes X / No		
12)	(a)	Proposed Well Work: Convert an existing ventilation borehole (Well No. L-		
(b)	If Stin	nulation Proposed, Describe Means to be Used to Stimulate Well: N/A		
.13)	(a)	Does the proposed operation plan to convert an existing well (as defined in W. \S 22-6-1) or a vertical ventilation hole to a coalbed methane well? Yes X	. Va. Code	
(b)	If yes, and a c <u>Casing</u>	please attach to this Application a list of all formations from which production i		
14)	(a)	Will the proposed coalbed methane well be completed in some but not all coal production (except for a gob well or vent hole proposed to be converted to a we Yes/ No/ N/A	-11)9	· Of
(b)	If yes, p workab	lease attach to this Application a plan and design for the well which will protect the coal seams which will be penetrated by the well.	WV Department of Environmental Protection and the state of the state o	NOV 2 1 2019
15)	(a)	Does the proposed operation include horizontal drilling of a well commenced on surface? Yes $\underline{\hspace{1cm}}/\hspace{1cm}$ No $\underline{\hspace{1cm}}X$	rent o	Oil and Gas
(b)	If yes, p	lease attach to this Application a description of such operations, including to		

If yes, please attach to this Application a description of such operations, including both the vertical and horizontal alignment and extent of the well from the surface to total depth.

CASING AND TUBING PROGRAM

061-01449-0

TYPE	SPECIFICATIONS		F007	CEMENT		
	- Size	Grade	Weight per ft.	For Drilling	Left in Well	Fill-up (cu. ft.)
Conductor						
Fresh Water						
Coal						
Intermediate						
Production						
Tubing						
Liners						
PACKERS:			VO CON MICH.			SM 9-5-02
	<u> </u>	LEASE SE	E ATTACH	ED WELL	REPORT	9-5-0,
						•
			,		********	
		For	Office of Oil 2	nd Gas Use Onl	ly	
	شبيو	ing	gencialing		 1	
Fee	e(s) paid:	Well Work I	Permit]	Reclamation Fun	nd WPC	CP
		9 ww				Agent

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WV Department of Environmental Protection Form WW-5(B)

47-061-01499 Page 3 of 3.

061-01449-4

CONSOLIDATION COAL COMPANY 1800 WASHINGTON ROAD PITTSBURGH PA

WELL NUMBER L-55			MINE	Loveridge
DATE STARTED ?			DATE COMPLETED.	?
CONTRACTOR ?		· .		
TOTAL DEPTH OF HOLE [In Feet]	980		(APPROX)	RECEIVED Office of Oil & Gas Permitting
	SLOTTED.	300		AUG 2 9 2002
[In Feet]	5-1/2-INCH 8-INCH	980 None		WV Department of Environmental Protection
PAC	CKER SIZE	Formation p	acker collar	
CEMENT ?		[SKS]		

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WV Department of Environmental Protection WR-35 Rev. 8/23/13

State of West Virginia Department of Environmental Protection - Office of Oil and Gas Well Operator's Report of Well Work

API 47 - 061 _ 01449 County Mono	ngalia	District Battelle	
Quad Mannington Pad Name Bow	vsher L-55	Field/Pool Name	
Farm name Bowsher, Robert		Well Number L-55	
Operator (as registered with the OOG) CNX Gas COmp	oany LLC	-	
		State PA	Zip 15317
T1-1- NT11 410001 40		Easting 1731186.09	
Bottom Hole Northing		Easting	
Elevation (ft) 1339 GL Type of Well	l □New ■ Existing	Type of Report	□Interim ■Final
Permit Type Deviated Horizontal Horizontal	ontal 6A Vertice	al Depth Type	□ Deep ■ Shallow
Type of Operation □ Convert □ Deepen □ Drill	□ Plug Back □ R	tedrilling Rework	□ Stimulate
Well Type □ Brine Disposal ■ CBM □ Gas □ Oil □ S	secondary Recovery	□ Solution Mining □ Sto	orage 🗆 Other
	•	_	
Type of Completion ■ Single □ Multiple Fluids Production ■ Cable ■ Rotary	duced 🗆 Brine 🖂	Gas DNGL DOIL	□ Other
Drilling Media Surface hole ■ Air □ Mud □ Fresh V Production hole ■ Air □ Mud □ Fresh Water □ Bri Mud Type(s) and Additive(s)		ate hole ■ Air □ Mud	□ Fresh Water □ Brine
Date permit issued9/17/2002 Date drilling cor	mmenced	Date drilling o	ceased
Date completion activities began			
Verbal plugging (Y/N) Date permission grant	ted	Granted by	
Please note: Operator is required to submit a plugging appl	ication within 5 days	of verbal permission to pl	lug
Freshwater depth(s) ft	Open mine(s) (Y/	N) depths	RECEIVED Office of Oil and Gas
Salt water depth(s) ft		red (Y/N) depths	
Coal depth(s) ft 970		tered (Y/N) depths	1151. 39/1119
Is coal being mined in area (Y/N) N			WV Department of Environmental Protection Reviewed by:

WR-35 Rev. 8/23/13 Page 2 of 4

API 47- 061	- 01449	Farm	name_Bowshe	r, Robert		Well n	umber_L-5	55	
CASING STRINGS	Hole Size	Casing Size	Depth	New or Used	Grade wt/ft		ısket pth(s)		nt circulate (Y/N) details below*
Conductor				1			O		
Surface					†				
Coal									
Intermediate 1									
Intermediate 2					1				
Intermediate 3							·····		
Production	6.75	5.5	980-1020					1	
Tubing									
Packer type and de	epth set	Formation Packet	er @ 680'-720						
Comment Details	Not sure on depti	ns due to variance in el	evation						
CEMENT	Class/Type	. Numi	ber Slur	гу	Yield	Volume	Ceme	ant	WOC
DATA Conductor	of Cement				t ³ /sks)	(ft. ³)	Top (M	(D)	(hrs)
Surface							<u> </u>		
Coal									
Intermediate 1									
Intermediate 2							ļ		
Intermediate 3									
Production							ļ		
Tubing							ļ		
Tubing									
Drillers TD (ft) Deepest format Plug back produced	tion penetrated	Pittsburgh Coal Sea	m		D (ft) to (ft)				
Kick off depth	(ft)			ethiniquides per la <u>una una commenta</u>					
Check all wire	line logs run	□ caliper □ neutror	•		ed/direction a ray		ection perature	□sonic	
Well cored	Yes 🗆 No	Convent	ional Side	wall	Wei	re cuttings co	ollected [Yes □	No
DESCRIBE TI	HE CENTRAL	JZER PLACEM	ENT USED FO	R EACH CA					
					***************************************			DEC	ENED
								Office of	Oil and Gas
***************************************			E 🗆 Yes 🗅					DE0	9 2019
WAS WELL C	COMPLETED	OPEN HOLE?	□Yes □ N	o DETA	AILS				partment of ntal Protection
WERE TRACE	ERS USED 0	Yes 🗆 No	TYPE OF T	RACER(S) I	JSED				

WR-	35	
Rev.	8/23/1	3

Page 3 of 4

API 47- 06	<u> </u>	01449	Farm name_	Bowsher,	Robert	Well number	L-55
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PERFORATION RECORD

Stage No.	Perforation date	Perforated from MD ft.	Perforated to MD ft.	Number of Perforations	Formation(s)
		<u> </u>			

Please insert additional pages as applicable.

STIMULATION INFORMATION PER STAGE

Complete a separate record for each stimulation stage.

Stage No.	Stimulations Date	Ave Pump Rate (BPM)	Ave Treatment Pressure (PSI)	Max Breakdown Pressure (PSI)	ISIP (PSI)	Amount of Proppant (lbs)	Amount of Water (bbls)	Amount of Nitrogen/other (units)
ļ								

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Please insert additional pages as applicable.

Office of Oil and Gas

DEC 9 2019

Page 4 of 4

API 47- 061	_ 01449	·····	Farm	name Bowshe	er, Robert		Well num	ber_L-55		
PRODUCING	FORMAT	ION(S)		<u>DEPTHS</u>						
Pittsburgh Coa	I Seam			970'-1010'	TVD		MD			
·	- 	······································				***				
							restanting.			
Please insert ac	lditional pa	iges as a	applicable.			-987-r-uitr-dentament and an annual and a				
GAS TEST	🗆 Build u	p o D	Prawdown	■ Open Flow		OIL TEST	Flow 🗆 Pu	np		
SHUT-IN PRE	SSURE	Surfac	e <u>1</u>	_psi Botto	om Hole	psi	DURATION	OF TEST _	hrs	8
OPEN FLOW		mcfpd	Oil	NGL bpd	_ bpd		GAS MEA		□ Pilot	
LITHOLOGY/ FORMATION	TOP DEPTH II NAME T	NFT I	BOTTOM DEPTH IN FT TVD	TOP DEPTH IN FT MD	BOTTOM DEPTH IN MD	FT DESCRIBE	ROCK TYPE AI	-		
Pittsburgh Coal	0		112	0	INID	TIFEOFF	LOID (FRESHW	AIEK, BRINE, C	JIL, GAS, H ₂ S	,EIC)
							······································	***************************************		
		-							· · · · · · · · · · · · · · · · · · ·	
T										
										
***************************************			***************************************					***************************************		
lease insert ad	ditional pa	ges as a	pplicable.							
Drilling Contra	ctor									
Address	A CANADA CONTRACTOR DE LA CANA			City			State	Zip		
ogging Compa	any			City			5 4. 4	 '		
				City			State	Zıp		
ementing Con	npany			City			State	7in	ي مواد الم	EWED
						A CONTRACTOR OF THE STATE OF TH	DiaiC	cıp		EIVED Oil and Ga
unuiating Col ddress	mpany			City		-	State	Zip	חבר	() 2040
lease insert add	ditional pa	ges as a	pplicable.						UEU	9 2019
ompleted by	Patrick Tay	/lor				Telephone	724-485-4150)	WV De	partment of ntal Protec
ignature /		7/		Title Sr		PHOHO		12/3/2019	PELIAMONING	

WW-4A Revised 6-07

1)	Date:	11/18/19
2)	Operator's V	Well Number
L-55		

3) API Well No.: 47 -

061 _ 01449

STATE OF WEST VIRGINIA DEPARTMENT OF ENVIRONMENTAL PROTECTION, OFFICE OF OIL AND GAS NOTICE OF APPLICATION TO PLUG AND ABANDON A WELL

(a) Name	Range Run Retreat		Name	Consolidated Coal Company			
Address	209 N Georgia Ave		Address	46226 National Road	1 1 1 1 - 1		
	Martinsburg, WV 25401			Saint Clarsville, OH 43950			
(b) Name			(b) Coal Ov	vner(s) with Declaration			
Address			Name	Curtis M Lemley			-
	= = 1 (1 - 1)		Address	186 Oak Drive	Щ	'F'	
				New Cumberland, WV 20047	≨. ≨	Z	Office
(c) Name			Name	Consolidated Coal Company	on V	2	6 7
Address			$\mathbf{Address}$	46226 National Road	epa	6	of O
				Saint Clairsville, OH 43950	파마	2	0 5
6) Inspector	Gayne Knitowski		(c) Coal Le	ssee with Declaration	rtment of al Protection	2019	3 E
Address	P.O. Box 108		Name		of		Gas
	Gormania, WV 26720		Address		on		S
Telephone	304-546-8171				F. M		
accompany Protection, the Applic	ying documents for a permit t with respect to the well at the	o plug and abandon a value location described on mailed by registered	well with the Chief of the n the attached Applicat or certified mail or de	operator proposes to file or has filed to the Office of Oil and Gas, West Virginion and depicted on the attached Form diversed by hand to the person(s) name	a Department of E WW-6. Copies o	invironm of this No	ental otice,
		Well Operator	CNX Gas Company LLC				
ALCOLOGY CON	IATHAN D. JONES	By:	Raymond Hoon	anne Rea			
	y Public Official Seal te of West Virginia	Its:	Senior Project Manager			1.1	1 1 1
	n. Expires Nov 27, 2021	Address	1000 Consol Energy Dr				
One Domini	on Drive Jane Lew WV 26378		Canonsburg, PA 15317				
		Telephone	724-485-4000			-15	
Subscribed and Jong than My Commission	D .	s_18 th di	ay of November	Notary Public			
Oil and Gas Priva	acy Notice						

The Office of Oil and Gas processes your personal information, such as name, address and phone number, as a part of our regulatory duties. Your personal information may be disclosed to other State agencies or third parties in the normal course of business or as needed to comply with statutory or regulatory requirements, including Freedom of Information Act requests. Our office will appropriately secure your personal information. If you have any questions about our use of your personal information, please contact DEP's Chief Privacy Officer at depprivacyoffier@wv.gov.

WW-9 (5/16)

API Number 47 - 0	61 _ 01449
Operator's Well No.	L-55


STATE OF WEST VIRGINIA DEPARTMENT OF ENVIRONMENTAL PROTECTION OFFICE OF OIL AND GAS

FLUIDS/ CUTTINGS DISPOSAL & RECLAMATION PLAN

Operator Name CNX Gas Company, LLC OP Code 494458046
Watershed (HUC 10) Range Run Quadrangle Mannington
Do you anticipate using more than 5,000 bbls of water to complete the proposed well work? Yes No
Will a pit be used? Yes No No
If so, please describe anticipated pit waste:
Will a synthetic liner be used in the pit? Yes No If so, what ml.?
Proposed Disposal Method For Treated Pit Wastes:
Land Application (if selected provide a completed form WW-9-GPP) Underground Injection (UIC Permit Number) Reuse (at API Number) Off Site Disposal (Supply form WW-9 for disposal location) Other (Explain
Will closed loop systembe used? If so, describe: no Service of Oil and Ga
Drilling medium anticipated for this well (vertical and horizontal)? Air, freshwater, oil based, etc NOV 2 1 2019
-If oil based, what type? Synthetic, petroleum, etc. na
Additives to be used in drilling medium?na
Drill cuttings disposal method? Leave in pit, landfill, removed offsite, etcna
-If left in pit and plan to solidify what medium will be used? (cement, lime, sawdust) na
-Landfill or offsite name/permit number? na
Permittee shall provide written notice to the Office of Oil and Gas of any load of drill cuttings or associated waste rejected at any West Virginia solid waste facility. The notice shall be provided within 24 hours of rejection and the permittee shall also disclose where it was properly disposed.
I certify that I understand and agree to the terms and conditions of the GENERAL WATER POLLUTION PERMIT issued on April 1, 2016, by the Office of Oil and Gas of the West Virginia Department of Environmental Protection. I understand that the provisions of the permit are enforceable by law. Violations of any term or condition of the general permit and/or other applicable law or regulation can lead to enforcement action. I certify under penalty of law that I have personally examined and am familiar with the information submitted on this application form and all attachments thereto and that, based on my inquiry of those individuals immediately responsible for obtaining the information, I believe that the information is true, accurate, and complete. I am aware that there are significant penalties for submitting false information, including the possibility of fine or imprisonment.
Company Official Signature JONATHAN D. JONES Notary Public Official Seal
Company Official (Typed Name) Raymond Hoon State of West Virginia
Company Official Title Senior Project Manager One Dominion Drive Jane Lew WV 26
1 Cth
Subscribed and sworn before me this 18th day of November , 20 19
Jonathan D. Jones War all Motary Public
My commission expires 11/27/2021

Operator's Well No. L55

	tment: Acres Disturbed 1.95			
Lime 2-3	Tons/acre or to correct t	to pH		
Fertilizer type 10-	20-20 or equivalent			
Fertilizer amount_5	500	lbs/acre		
Mulch hay or stra	w 2	Tons/acre		
_		Seed Mixtures		
	emporary		Permanent	
Seed Type	lbs/acre	Seed Type		s/acre
Tall Fescue	40	Tall Fescue	40	
Landino Clover	5	Landino Clover	5	
Attach: Maps(s) of road, location, p provided). If water from the (L, W), and area in acres, of	pit will be land applied, provi	application (unless engineered plans ide water volume, include dimension	including this intens (L, W, D) of the	fo have been ne pit, and dimension
Maps(s) of road, location, p provided). If water from the (L, W), and area in acres, of	pit will be land applied, provi	application (unless engineered plans ide water volume, include dimension	including this int ns (L, W, D) of th	fo have been ne pit, and dimension
Maps(s) of road, location, p provided). If water from the (L, W), and area in acres, of	pit will be land applied, proviethe land application area. lved 7.5' topographic sheet.	application (unless engineered plans ide water volume, include dimension	ns (L, W, D) of th	ne pit, and dimension
Maps(s) of road, location, p provided). If water from the (L, W), and area in acres, of Photocopied section of invo	pit will be land applied, proviethe land application area. lved 7.5' topographic sheet.	ide water volume, include dimension	ns (L, W, D) of th	ne pit, and dimension
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Maps(s) of road, location, p provided). If water from the (L, W), and area in acres, of Photocopied section of invo	pit will be land applied, provide the land application area. lved 7.5' topographic sheet.	ide water volume, include dimension	ns (L, W, D) of the	RECEIVED Office of Oil and Ga NOV 2 1 2019 WV Department of
Maps(s) of road, location, p provided). If water from the (L, W), and area in acres, of Photocopied section of invo	pit will be land applied, provide the land application area. lved 7.5' topographic sheet.	ide water volume, include dimension	ns (L, W, D) of the	RECEIVED Office of Oil and Ga NOV 2 1 2019 WV Department of

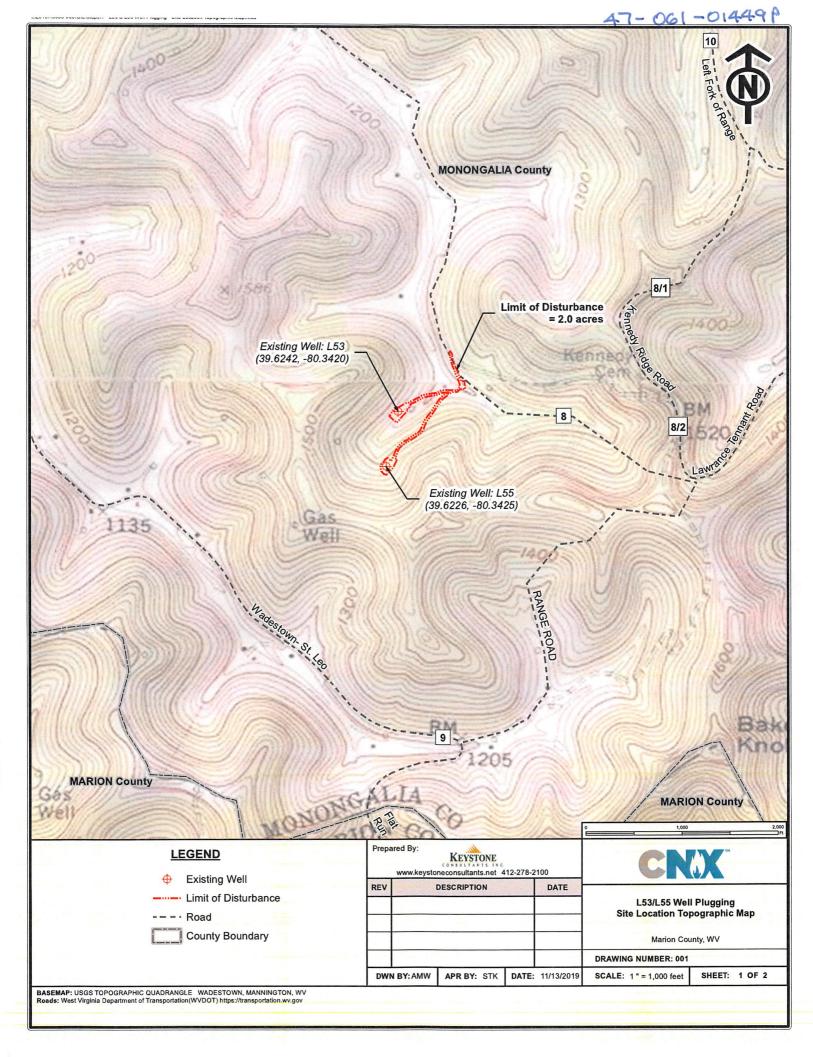



West Virginia Department of Environmental Protection Office of Oil and Gas

WELL LOCATION FORM: GPS

API: 4704901449 WELL NO.: L55	
FARM NAME: Bowsher	
RESPONSIBLE PARTY NAME: CNX Gas Company	
COUNTY: Monongalia DISTRICT: Battelle	
QUADRANGLE: Mannington	RANK III
surface owner: Range Run Retreat LLC	
ROYALTY OWNER:	
UTM GPS NORTHING: 4386078.98	
UTM GPS EASTING: 556432.02 GPS ELEVATION:	108.03m / 1338.67 ft
The Responsible Party named above has chosen to submit GPS coordinates preparing a new well location plat for a plugging permit or assigned API nu above well. The Office of Oil and Gas will not accept GPS coordinates that the following requirements: 1. Datum: NAD 1983, Zone: 17 North, Coordinate Units: meters, A height above mean sea level (MSL) – meters. 2. Accuracy to Datum – 3.05 meters 3. Data Collection Method: Survey grade GPS: Post Processed Differential	mber on the do not meet
Real-Time Differential	
Mapping Grade GPS X : Post Processed Differential X	
Real-Time Differential4. Letter size copy of the topography map showing the well loca	tion
I the undersigned, hereby certify this data is correct to the best of my knowl belief and shows all the information required by law and the regulations issuprescribed by the Office of Oil and Gas.	edge and
Signature Project MANAGER 12) - 4 - 15 Date

L53 / L55 WELL PLUGGING

BATTELLE DISTRICT, MONOGALIA COUNTY, WEST VIRGINIA PREPARED FOR: CNX GAS COMPANY, LLC

WELL LOCATION: L53: LAT 39.62391 LONG -80.34226

L55: LAT 39.62262 LONG -80.34233

ACCESS ROAD LOCATION: LAT 39.625896 LONG -80.340132

WATERSHED: UNT TO RANGE RUN





908 QUANTIES
300 INDEX SHEET
301 SITE RESTORATI
302 SITE RESTORATI
303 SITE RESTORATI
304 SITE RESTORATI

GENERAL NOTES

REVIS ONS





KEYSTONE
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CARREGGE, PA 15106
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ISTRICT, MONDGALIA COUNTY, WEST VI

DRAWING NUMBER 000 SHEET 01 OF 14

OCTOBER 2019

KEYSTONE CONSULTANTS, LLC

SITE DATA:

TOTAL LIMIT OF DISTURBANCE = 1.95 ACRES

DEVELOPER: CNX GAS COMPANY, LLC. 1000 CONSOL ENERGY DRIVE SUITE 200 CANONSBURG, PA 15317

GENERAL NOTES

CRITICAL AREAS

CONTRACTOR SHALL INSPECT SITE FOR CRITICAL AREAS INCLUDING BUT NOT LIMITED TO STEEP SLOPES, STREAMS, WETLANDS, WATER WELLS/SPRINGS, SEEPS, SLIPS, AND AREAS OF CONCENTRATED FLOW. EAS CONTROL BUPS WILL BE UTILIZED TO REMOVE SEDIMENT FROM STORWANTER RUNOFF PRIOR TO DISCHARGE FROM THE SITE. ALSO, EROSION CONTROL BILANKET HAS BEEN SPECIFIED TO REDUCE EROSION AND STABLES SLOPES AND WHERE SLIPS MAY OCCUR. FOLLOW GUIDANCE IN ENVIRONMENTAL PERMITS FOR WATERBOOT CROSSING BMPS.

PRIOR TO BEGINNING LAND DISTURBING ACTIVITIES, CLEARLY MARK ALL CLEARING LIMITS, SENSITIVE AREAS AND THESE THAT ARE TO BE PRESERVED WITHIN THE CONSTRUCTION AREA. THESE SHEET CLEARLY MARKED, BOTH IN THE FIELD AND ON THE PLANS, TO PREVENT DAMAGE AND OFFICE IMPACTS.

SITE ACCESS

INSTALL STABILIZED CONSTRUCTION ENTRANCE AS SHOWN ON PLANS, AVOID EXCESSIVE RUTTING AND SEDIMENT CAUSING ACTIVITIES DURING SITE ACCESS.

NO SEDIMENT TRACKING ON THE ROADWAY IS ALLOWED. IN THE EVENT THAT SEDIMENT IS INADVERTENTLY TRACKED ONTO THE ROAD, THE ROAD SHALL BE CLEANED THOROUGHLY BY THE END OF EACH DAY. SEDIMENT SHALL BE REMOVED FROM ROADS BY SHOVELING OR PICKUP SWEEPING AND SHALL BE TRANSPORTED TO A CONTROLLED SEDIMENT DISPOSAL AREA STREET WASHING OF SEDIMENT TO THE STORM DRAIN SYSTEM IS NOT ALLOWED, IF STREET WASH WASTEWAYER OAN BE CONTROLLED THE STORM DRAINER OAD BE CONTROLLED THE STORM DRAINER OAD BE CONTROLLED THE STREET WASHING THE STORM DRAINER OAD BE CONTROLLED THE STREET WASHING THE STORM DRAINER OAD BE CONTROLLED THE STREET WASHING THE STORM DRAINER OAD BE CONTROLLED THE STREET WASHING THE STORM DRAINER OAD BE CONTROLLED THE STREET WASHING TH

EROSION AND SEDIMENT CONTROL

EAS BMPS ARE TO BE INSTALLED PRIOR TO THE BEGINNING OF EARTH DISTURBANCE ON THE SITE. BMPS SHALL BE INSTALLED IN ACCORDANCE WITH STANDARD DETAILS FROM THE WWDEP EROSION AND SEDIMENT CONTROL BUP MANUAL. CONTRACTOR SHALL PERFORM AN INSPECTION OF BMPS NORE PREVEN CALENDAR DAYS AND AFTER EACH RAINFALL EVENT. INSPECTIONS SHALL BE LOGGED ON THE STANDARD INSPECTION FOR AND KEPT WITH CONSTRUCTION, SITE SUPERVISOR SHOULD REVIEW PROPER BMP INSTALLATION AND MAINTENANCE WITH CONSTRUCTION, SITE SUPERVISOR SHOULD REVIEW PROPER BMP INSTALLATION AND MAINTENANCE WITH CONSTRUCTION PERSONNEL.

STABILIZE SOILS

EXPOSED AND UNWORKED SOILS SHALL BE STABILIZED BY APPLICATION OF EFFECTIVE BMPS THAT PROTIECT THE SOIL FROM THE EROSIVE FORCES OF RANDROPS, FLOWING WATER, AND WIND. THE GENERAL PERMIT REQUISES HAVE LIKE PROPERTY AND THE SELECT AND MILCHED WITHIN 7. DAYS, WHERE THE WITHINDON OF STABILIZATION FLOWERS FOR SELECTION ACTIVITY THE THEOROGARILY OF PERMINANTIVITY CEASES OR IS PRECLUED BY SNOW CONSTRUCTION ACTIVITY THEOROGARILY OF PERMINANTIVITY CEASES OR IS PRECLUED BY SNOW CONSTRUCTION ACTIVITY HAVE DEPENDED BY SNOW CONSTRUCTION ACTIVITY BY THE PROPORTIVE STABILIZATION MEASURES SHALL BE INITIATED AS SOON AS CONDITIONS ALLOW WHERE CONSTRUCTION ACTIVITY BY THE PROPORTIVE STABILIZATION MEASURES DO THE SITE WITHIN 21 DAYS FROM WHEN ACTIVITIES CASES (E.G., THE TOTAL TIME PERIOD THAT CONSTRUCTION ACTIVITY IS TEMPORARILY HAUTED IS LESS THAN 21 DAYS) THEN STABILIZATION MEASURES DO NOT HAVE TO DE INSTITUTE ON THAT FOR THE SITE BY THE SEVENTH DAY AFTER CONSTRUCTION ACTIVITIES HAVE TEMPORARILY CEASED.

LINEAR CONSTRUCTION ACTIVITIES SUCH AS RIGHT—OF—WAY AND EASEMENT CLEARING, ROADWAY DEVELOPMENT, HIPELINES, AND TRENCHING FOR UTILITIES, SHALL BE CONDUCTED TO MEET THE SOLI STABILIZATION TIMEFRAME, REQUIREMENTS, CONTRACTORS SHALL INSTALL THE BEDDING MATERIALS, ROADBEDS, STRUCTURES, PIPELINES, OR UTILITIES AND RE—STABILIZE THE DISTURBED SOILS SO THAT THE 7—DAY REQUIREMENTS ARE MET.

CONVEY STORMWATER IN A NON-EROSIVE MANNER

POINTS OF DISCHARGE AND RECEIVING STREAMS SHALL BE PROTECTED FROM EROSION DUE TO INCREASES IN THE VOLUME, VELOCITY, AND PEAK FLOW RATE OF SURFACE WATER RUNOFF FROM THE PROJECT SITE.

WHENEVER A DEFICIENCY IN AN EAS BMPS IS NOTED, THE CONTRACTOR SHALL REPAIR THE BMP IMMEDIATELY. BMPS SHOWN ON THE PLAN ARE A MINIMUM TO CONTROL EROSION AND SEDMENT EXPECTED ONSITE. SHOULD CONDITIONS IN THE FIELD COCLU WHERE BMP FALLINE IS NOTED. STEE SUPERVISOR SHALL INSTALL ADDITIONAL BMPS AS NECESSARY TO PREVENT RELEASE OF SEDMENT FROM THE SITE. MINOR CHANGES SHOULD BE LOCGED ON THE ONSITE COPY OF THE PLAN FOR REFERENCE. ENVIRONMENTAL COORDINATOR SHOULD BE NOTIFIED OF ANY MAJOR EAS ISSUES.

CONTROL OTHER POLLUTANTS

GROUNDWATER PROTECTION BMPS SHOULD BE FOLLOWED TO PREVENT RISKS ASSOCIATED WITH FUELS, MATERIALS, AND CHEMICALS THAT ARE TO BE USED ON SITE. POLLUTIANTS STORED ON SITE SHOULD BE KEPT COVERED AND WITHIN SECONDARY CONTINUMENT CONTINUMENT ROFULD BE REQUIRELY MONITORED FOR SIGNS OF LEAKS. FOLIPHENT REFUELING SHOULD TAKE FLACE WITH ADEQUATE DRIP PROTECTION AND EQUIPMENT SHOULD BE REGULARLY MONITORED LEAKS. SPULLS AND LEAKS SHALL BE PROMPTLY CLEANED UP. IF A SPILL OCCURS THAT MAY CONTAMINATE SURFACE WATERS SUPERVISOR SHALL MOTIFY ENVIRONMENTAL COORDINATOR IMMEDIATELY AND THE WYDEP AND NATIONAL RESPONSE CENTER SHALL BE NOTIFIED AS NECESSARY.

ALL POLLUTANTS, INCLUDING WASTE MATERIALS AND DEMOLITION DEBRIS, THAT OCCUR ON SITE DURING CONSTRUCTION SHALL BE HANDLED AND DISPOSED OF IN A MANNER THAT DOES NOT CAUSE CONTAMINATION OF SURFACE WATER. WOODY DEBRIS MAY BE CHOPPED AND SPREAD ON SITE.

APPLICATION OF AGRICULTURAL CHEMICALS INCLUDING FERTILIZERS AND PESTICIDES SHALL BE CONDUCTED IN A MANNER AND AT APPLICATION RATES THAT WILL NOT RESULT IN LOSS OF CHEMICAL TO SURFACE WATER RUNOFF, MANUFACTURERS' RECOMMENDATIONS FOR APPLICATION RATES AND PROCEDURES SHALL BE FOLLOWED.

MANAGING THE PROJECT

A COPY OF THE E&S PLAN IS TO REMAIN ON SITE AT ALL TIMES FOR THE DURATION OF THE PROJECT. THE E&S PLAN IS TO BE MODIFIED WHENEVER THERE IS A CHANGE IN DESIGN, CONSTRUCTION, OPERATION OF MAINTENANCE OF BMPS.

TREE CLEARING SHALL BE MINIMIZED TO THE EXTENT NECESSARY AND COMPACTION OF EXISTING SOILS SHOULD BE MINIMIZED TO THE EXTENT PRACTICABLE.

INSPECTION AND MONITORING — ALL BMPS SHALL BE INSPECTED, MAINTAINED, AND REPAIRED AS NEEDED TO ASSURE CONTINUED PERFORMANCE OF THEIR INTENDED FUNCTION. WHENEVER INSPECTION AND/OR MONITORING REVEALS THAT THE BMPS IDENTIFIED IN THE SCP ARE INADEQUATE, THE SCP SHALL BE MODIFIED, AS APPROPRIATE, IN A TIMELY MANNER.

REPORTING - REPORT SPILLAGE OR DISCHARGE OF POLLUTANTS WITHIN 24-HOURS.

EQUIPMENT MAINTENANCE — MAINTENANCE AND REPAIR OF HEAVY EQUIPMENT AND VEHICLES INVOLVING OIL CHANGES, HYDRAULD SYSTEM DRAIN DOWN, SOLVENT AND DE-GREASING CLEANING OPERATIONS, FUEL TANK DRAIN DOWN AND REMOVAL, AND OTHER ACTIVITIES WHICH MAY RESULT IN DISCHARGE OR SPILLAGE OF POLLUTIANTS TO THE GROUND OR INTO SURFACE WATER RUNOFF MUST BE CONDUCTED USING STAPP LARGE WATER RUNOFF MUST BE CONDUCTED USING STAPP PANS. CONTAMINATED SIGN. MUST BE DISCOSED OF PROPERTY. POLLOWING, ANY DISCHARGE OR SPILL INCIDENT. CONTAMINATED SIGN. MUST BE DISCOSED OF PROPERTY. EMERGENCY REPAIRS MAY BE PERFORMED ON—SITE USING TEMPORARY PLASTIC PLACED BENEATH AND, IF RAINING, OVER THE YERICE.

VEGETATIVE STABILIZATION

THE CONSTRUCTION SITE SHOULD BE STABILIZED AS SOON AS POSSIBLE AFTER COMPLETION ESTABLISHMENT OF FINAL COVER MUST BE INITIATED NO LATER THAN 7 DAYS AFTER REACHING FINAL GRADE. FINAL STABILIZATION MEANS THAT ALL SOIL—DISTURBING ACTIVITIES ARE COMPLETED, AND THAT EITHER A PERMANENT VEGETATIVE COVER WITH A DENSITY OF 70% OR GREATER HAS BEEN ESTABLISHED OR THAT THE SURFACE HAS BEEN ESTABLISHED BY HAND COVER SUCH AS PAVEMENT OR BUILDINGS. IT SHOULD BE NOTED THAT THE 70% REQUIREMENT REFERS TO THE TOTAL AREA VEGETATED AND NOT JUST A PERCENT OF THE STIE.

NOTES:

- 1. THIS PLAN IS FOR EROSION & SEDIMENT CONTROL AND SITE RESTORATION PURPOSES ONLY.
- Existing conditions as depicted on these plans are general and illustrative in nature. It is the responsibility of the contractor to examine the site and be familiar with existing conditions prior to bidding on this project. If conditions encountered during examination are significantly different than those shown, the contractor shall notify the engineer immediately.
- 3. THE CONTRACTOR AND SUBCONTRACTORS SHALL BE RESPONSIBLE FOR COMPLYING WITH APPLICABLE FEDERAL, STATE AND LOCAL REQUIREMENTS, TOGETHER WITH EXERCISING PRECAUTIONS AT ALL TIMES FOR THE PROTECTION OF PERSONS (INCLUDING EMPLOYEES) AND PROPERTY. IT IS THE SOLE RESPONSIBILITY OF THE CONTRACTOR AND SUBCONTRACTORS TO INITIATE, MAINTAIN AND SUPERVISE ALL SAFETY REQUIREMENTS PERCALIFIONS AND PROCRAMMS IN CONNECTION WITH THE WORK.
- 4. THE CONTRACTOR SHALL INDEMNIFY AND HOLD HARMLESS THE OWNER AND OWNER'S REPRESENTATIVE FOR ANY AND ALL INJURIES AND/OR DAMAGES TO PERSONNEL, EQUIPMENT AND/OR EXISTING FACILITIES OCCURRING IN THE COURSE OF THE CONSTRUCTION DESCRIBED IN THE PLANS AND SPECIFICATIONS.
- THE CONTRACTOR SHALL COMPLY WITH ALL LOCAL CODES, OBTAIN ALL APPLICABLE PERMITS, AND PAY ALL REQUIRED FEES PRIOR TO BEGINNING WORK.
- CONTRACTOR SHALL REFER TO OTHER PLANS WITHIN THIS CONSTRUCTION SET FOR OTHER PERTINENT INFORMATION. IT IS NOT THE ENGINEER'S INTENT THAT ANY SINGLE PLAN SHEET IN THIS SET OF DOCUMENTS PLULY DEPICT ALL WORK ASSOCIATED WITH THE PROJECT.
- ANY DISTURBED AREA THAT HAS REACHED FINAL GRADE OR IS TO REMAIN IDLE FOR MORE THAN 21 DAYS IS TO BE TEMPORARILY SEEDED AND MULCHED WITHIN 7 DAYS.
- 8. REFER TO THE STANDARD DETAILS FOR INSTALLATION AND MAINTENANCE GUIDELINES FOR PROPOSED BMPS.
- NO WETLAND OR STREAM CROSSING OTHER THAN THOSE PERMITTED IS AUTHORIZED WITHOUT PRIOR CONSULTATION WITH REVIEWING AGENCIES. LIMITS OF IMPACT TO WETLANDS AND WATERBODIES ARE SHOWN ON THE PLANS.


CONSTRUCTION WASTE RECYCLING/ DISPOSAL:

- CONSTRUCTION WASTES ARE REFUSE MATERIALS GENERATED DURING THE COURSE OF CONSTRUCTION AND INCLUDE, BUT ARE NOT LIMITED TO, PAPER, PLASTIC, WOOD, FOOD, TEXTILE, AND METAL PRODUCTS.
- 2. 3. THE CONTRACTOR SHALL BE RESPONSIBLE FOR IDENTIFYING WASTE RECYCLING/DISPOSAL AREAS ON THE EAS PLAN ONCE THEY HAVE BEEN DETERMINED. THE CONTRACTOR SHALL BE RESPONSIBLE FOR OBTAINING ALL WASTE RECYCLING/DISPOSAL PERMITS PRIOR TO THE COMMENCEMENT OF CONSTRUCTION ACTIVITIES.

CONSTRUCTION SEQUENCE

- THE CONTRACTOR SHALL PLACE A WEST VIRGINIA ONE CALL NO LATER THAN TWO (2) WORKING DAYS AND NO MORE THAN 10 WORKING DAYS PRIOR TO CONSTRUCTION.
- PRIOR TO COMMENCEMENT OF ANY EARTH DISTURBANCE ACTIVITY INCLUDING CLEARING AND GRUBBING, THE REGISTRANT SHALL CLEARLY DELINEATE SENSITIVE AREA, LIMIT OF DISTURBANCE, AND TREES THAT ARE TO BE CONSERVED WITHIN THE PROJECT SITE, AND SHALL INSTALL APPROPRIATE BARRIERS WHERE EQUIPMENT MAY NOT BE PARKED, STAGED, OPERAIRED OR LOCATED FOR ANY PURPOSE.
- 3. INSTALL STABILIZED CONSTRUCTION ENTRANCE AS NECESSARY, AS SHOWN ON THE PLANS.
- 4. UTILIZING THE STABILIZED CONSTRUCTION ENTRANCE FOR SITE ACCESS, INSTALL PERIMETER CONTROLS, SUCH AS FILTER SOCK, AS SHOWN ON THE PLANS,
- 5. WITH PERIMETER EAS CONTROLS IMPLEMENTED, THE CONTRACTOR SHALL PERFORM ROAD MAINTENANCE AS NECESSARY AND COMMENCE WITH WELL PLUGGING, AFTER PROJECT COMPLETION, DISTURBED AREAS SHALL BE RESTORED TO APPROXIMATE ORIGINAL CONTOURS AND PERMANENTLY SEEDED AND MULCHED. EROSION BLANKET SHALL BE APPLIED AS SHOWN ON THE PLANS.
- 6. UPON ESTABLISHMENT OF UNIFORM 70% VEGETATIVE COVER, THE CONTRACTOR SHALL REMOVE E&S BMPS.



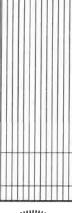





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EXSTONE
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CARREGIE, PA 15106
CARREGIE, PA 15106
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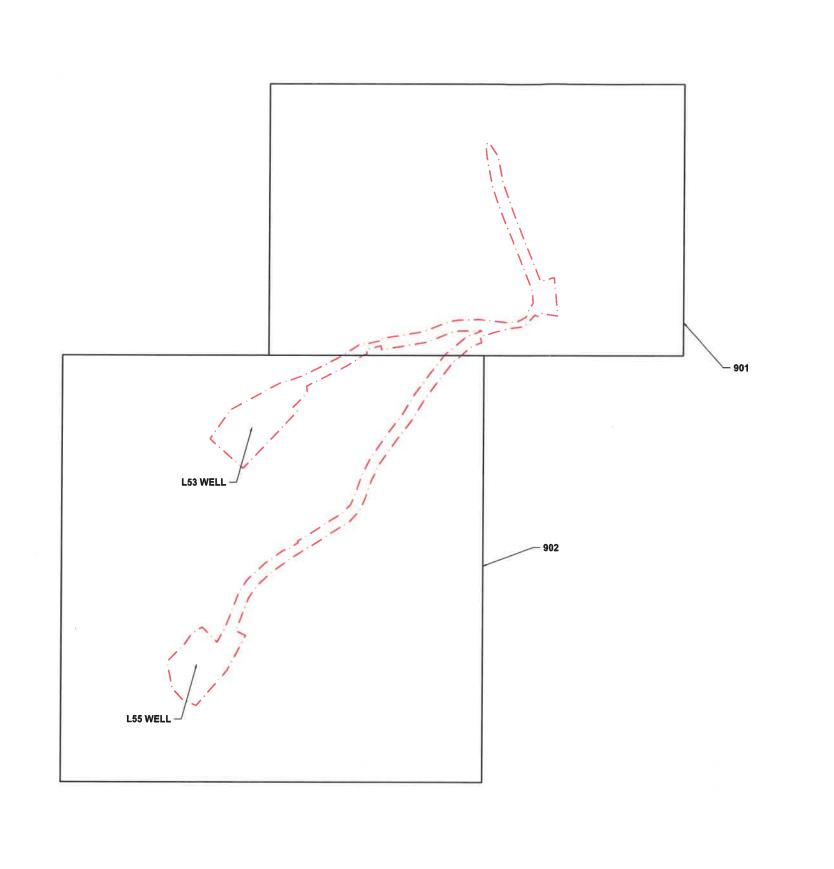
STK EAZ IZ019

NO N

L53 / L55 WELL PLUGGING

DRAWING NUMBER

SHEET 02 OF 14



--- EXISTING PROPERTY LINE EXISTING INDEX CONTOUR EXISTING INTERMEDIATE CONTOUR --- EXISTING UNPAVED DRIVEWAY ===== EXISTING CULVERT EXISTING WATERBODY AND STREAM (DELINEATED) FLOODWAY BASED ON 50' OFFSET DAYSTING WETLAND

OHW EXISTING OVERHEAD ELECTRIC LINE

EXISTING UTILITY POLE, LIGHT POLE, GLY WIRE --- EXISTING GAS LINE EXISTING SOIL TYPE EXISTING TREELINE EXISTING WELL HEAD
PROPOSED LIMIT OF DISTURBANCE PROPOSED INTERMEDIATE CONTOUR --- --- PROPOSED PAD A PROPOSED COMPOST FILTER SOCK ID -12-12- PROPOSED 12" COMPOST FILTER SOCK -32-32- PROPOSED 32" COMPOST FILTER SOCK

NOTE

- CONTRATOR TO USE EXISTING ACCESS ROAD AND MAINTAIN AS NECESSARY.
- CONTRACTOR TO PLACE GEO-TEXTILE AND AGGREGATE ON ACCESS ROAD AS NECESARY.
 SEE DETAIL 5 ON PAGE 903.





KEYSTONE
CONSULTANTS, L.C.
32 EAST MAIN STREET
CANNEGIE EN 51006
PRACH 272-2106 PRACH 272-2106

OHECKED STK
APPROVED STK

DAIR 11/13/2019
STAL 1** = 100


LS3 / LS5 WELL PLUGGING
STRICT. MONOGALIA COUNTY, WEST VIR
INDEX SHEET

BATTELLE DISTRICT,
BATTELLE DISTRICT,
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DRAWING NUMBER

900 SHEET 03 OF 14


SCALE IN FEET

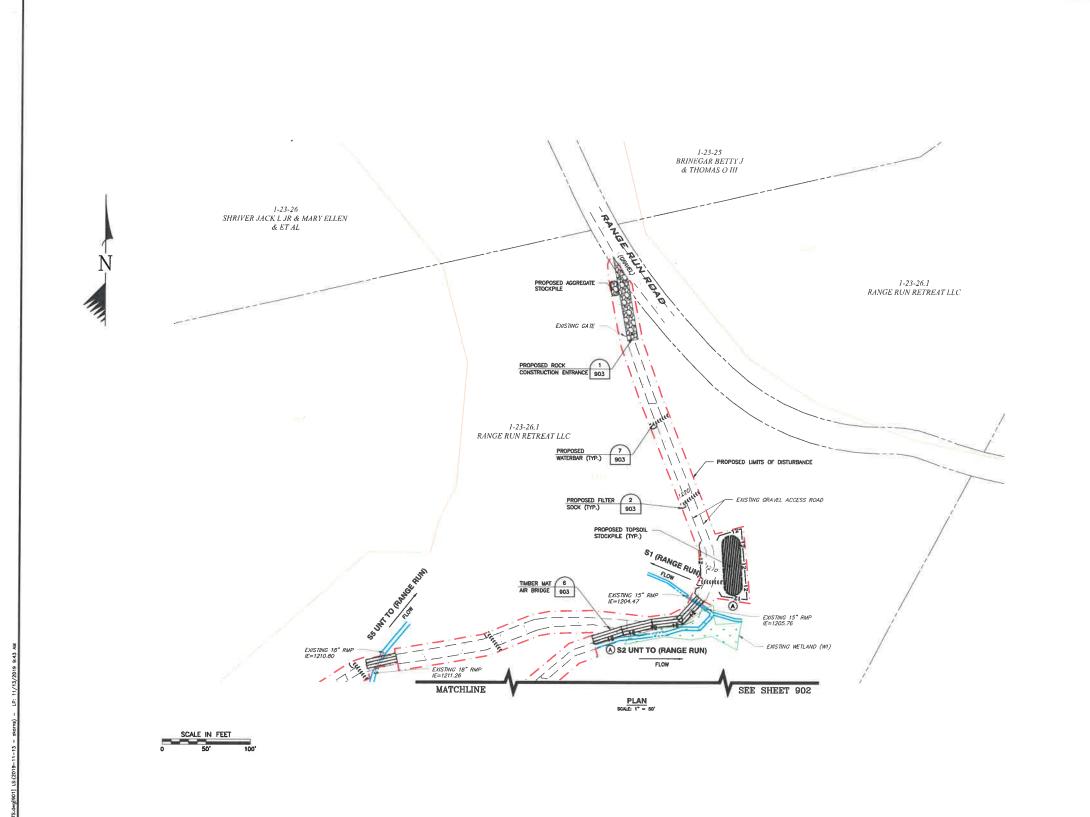

----- EXISTING PROPERTY LINE EXISTING INTERMEDIATE CONTOUR — EXISTING UNPAVED DRIVEWAY ---- EXISTING CULVERT - Existing waterbody and stream (delineated) FLOODWAY BASED ON 50' OFFSET EXISTING WETLAND - EXISTING OVERHEAD ELECTRIC LINE EXISTING UTILITY POLE, LIGHT POLE, GUY WIRE ------ EXISTING GAS LINE EXISTING SOIL TYPE EXISTING WELL HEAD ---- PROPOSED LIMIT OF DISTURBANCE --- PROPOSED INTERMEDIATE CONTOUR - -- PROPOSED PAD **(A)** PROPOSED COMPOST FILTER SOCK ID ----12----- PROPOSED 12" COMPOST FILTER SOCK -32-32- PROPOSED 32" COMPOST FILTER SOCK PROPOSED ROCK CONSTRUCTION ENTRANCE (20) PROPOSED AGGREGATE STOCKPILE ш PROPOSED 4'X16'X8" WETLAND CROSSING STABILIZATION PROPOSED EROSION CONTROL BLANKET PROPOSED 35'X10' AIR BRIDGE

- . CONTRATOR TO USE EXISTING ACCESS ROAD AND MAINTAIN AS NECESSARY.
- CONTRACTOR TO PLACE GEO.-TEXTILE AND AGGREGATE ON ACCESS ROAD AS NECESARY.
 SEE DETAIL 5 ON PAGE 903.

COMPOST FILTER SOCK SIZING T					
LABEL	SIZE	DETAIL			
®	12"	903			

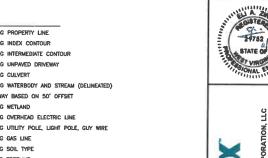

CAS

KEYSTONE

N S U L T A N T S, L L C

32 EAST MAIN STREET
CARNEGIE, PA 15106...

L53 / L55 WELL PLUGGING

EROSION AND SEDIMENTATION CONTROL PLAN BATTELLE DISTR

DRAWING NUMBER

901 SHEET 04 OF 14 INSTALLATION SECTION A-A

USE LARGER STONE (4-6 INCH) FOR HEAVY USE OR MATERIAL DELIVERY ENTRANCES.

LENGTH IS AS REQUIRED, BUT NOT LESS THAN 70 FEET (RCE TO BE PLACED JUST PAST THE LAST DWELLING TO PROVIDE RESIDENT A CLEAN PASSAGE WHERE A 70 FOOT MINIMUM LENGTH WOULD APPLY).

1. THICKNESS SHOULD BE NOT LESS THAN 6 INCHES:
1. THICKNESS SHOULD BE NOT LESS THAN 6 INCHES:
1. THE WIDTH SHALL BE A MINIMUM OF 10 FEET, BUT NOT LESS THAN THE FULL WIDTH AT POINTS WHERE INGRESS OR EGRESS OCCURS.
1. CECITEMILE FABRIC SHALL BE PLACED OVER THE ENTIRE AREA PRIOR TO THE PLACING OF STONE.
1. ALL SURFACE WATER FLOWING OR DIVERTED TOWARD CONSTRUCTION ENTRANCES SHALL BE PIPED ACROSS THE ENTRANCE. FA CULVER'I SI IMPRACTICAL, A MOLITIFIED ERRM WITH 51 SLOPES SHALL BE USED.

IF NECESSARY, DIVERT ANY WATER RUNNING DOWN ACCESS ROAD TO A SUMP LOCATED ON EITHER SIDE OF THE STABILEED CONSTRUCTION ENTRANCE.


MAINTENANCE

- THE ENTRANCE SHALL BE MAINTAINED IN A CONDITION THAT WILL PREVENT TRACKING OR FLOWING OF SEDIMENT ONTO PUBLIC RIGHTS-OF-WAY. THIS MAY REQUIRE PERIODIC TOP DRESSING WITH ADDITIONAL STONE AS CONDITIONS DEMAND AND REPAIR AND/OR CLEANOUT OF ANY MESSURES USED TO TRAP SEDIMENT ALL SEDIMENT SPILLED, DROPPED, WASHED OR TRACKED ONTO PUBLIC RICHTS-OF-WAY MUST BE REMOVED IMMEDIATELY.

 WHELES ON ALL VEHICLES SHALL BE CLEANED TO REMOVE SEDIMENT FRIOR TO ENTRANCE ONTO PUBLIC RICHTS-OF-WAY.


 INSPECTION AND NEEDED MAINTENANCE SHOULD BE PROVIDED DAILY BUT AT A MINIMUM EVERY SEVEN DAYS AND AFTER EVERY RAIN OF 0.5 INCH OR GREATER

DETAIL 1 STABILIZED CONSTRUCTION ENTRANCE

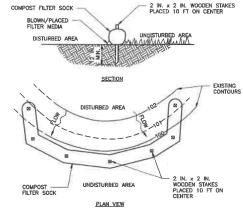


- SOCK FABRIC SHALL MEET THE REQUIREMENTS OF THE COMPOST FILTER SOCK MINIMUM SPECIFICATIONS TABLE. COMPOST SHALL MEET THE STANDARDS OF THE COMPOST STANDARDS TABLE.
- COMPOST FILTER SOCK SHALL BE PLACED AT EXISTING LEVEL GRADE. BOTH ENDS OF THE BARRIER SHALL BE EXTENDED AT LEAST 8 FEET UP SLOPE AT 45 DEGREES TO THE MAIN BARRIER ALIGNMENT. MAXIMUM SLOPE LENGTH ABOVE ANY BARRIER SHALL NOT EXCEED THAT SPECIFIED FOR THE SIZE OF THE SOCK AND THE SLOPE OF ITS TRIBUTIARY AREA.
- 3. TRAFFIC SHALL NOT BE PERMITTED TO CROSS COMPOST FILTER SOCKS.
- . ACCUMULATED SEDIMENT SHALL BE REMOVED WHEN IT REACHES 1/2 THE ABOVE GROUND HEIGHT OF THE BARRIER AND DISPOSED IN THE MANNER DESCRIBED ELSEWHERE IN THE PLAN.
- . COMPOST FILTER SOCKS SHALL BE INSPECTED WEEKLY AND AFTER EACH RUNOFF EVENT, DAMAGED SOCKS SHALL BE REPAIRED ACCORDING TO MANUFACTURER'S SPECIFICATIONS OR REPLACED WITHIN 24 HOURS OF
- BIODEGRADABLE COMPOST FILTER SOCKS SHALL BE REPLACED AFTER 6 MONTHS; PHOTODEGRADABLE SOCKS AFTER 1 YEAR. POLYPROPYLENE SOCKS SHALL BE REPLACED ACCORDING TO MANUFACTURER'S
- UPON STABILIZATION OF THE AREA TRIBUTARY TO THE SOCK, STAKES SHALL BE REMOVED. THE SOCK MAY BE LEFT IN PLACE AND VEGETATED OR REMOVED. IN THE LATTER CASE, THE MESH SHALL BE CUT OPEN AND THE MULCH SPREAD AS A SOIL SUPPLEMENT.

DETAIL 2 COMPOST FILTER SOCK NOT TO SCALE

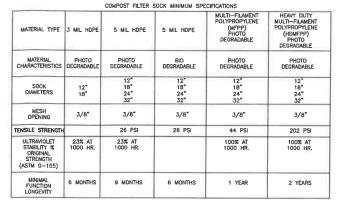


ORGANIC MATTER CONTENT	25%-100% (DRY WEIGHT BASIS)		
ORGANIC PORTION	FIBROUS AND ELONGATED 5.5-8.5		
ρН			
MOISTURE CONTENT	30%-60%		
PARTICLE SIZE	30% - 50% pass through %" sieve		
SOLUABLE SALT CONCENTRATION	5.0 dS/m (mmhos/cm) MAXIMUM		

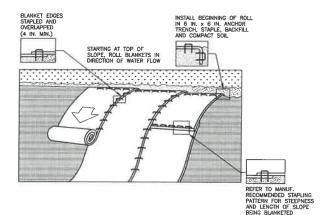

SEED AND SOIL AMENDMENTS SHALL BE APPLIED ACCORDING TO THE RATES IN THE PLAN DRAWINGS PRIOR TO INSTALLING THE BLANKET.

- 2. PROVIDE ANCHOR TRENCH AT TOE OF SLOPE IN SIMILAR FASHION AS AT TOP OF SLOPE.
- 3. SLOPE SURFACE SHALL BE FREE OF ROCKS, CLODS, STICKS, AND GRASS.
- 5. THE BLANKET SHALL BE STAPLED IN ACCORDANCE WITH THE MANUFACTURER'S RECOMMENDATIONS.
- BLANKETED AREAS SHALL BE INSPECTED WEEKLY AND AFTER EACH RUNOFF EVENT UNTIL PERENNAL VEGETATION IS ESTABLISHED TO A INMIXIMU UNFORM 70% COVERAGE THROUGHOUT THE BLANKETED AREA. DAMAGED OR DISPLACED BLANKETS SHALL BE RESTORED OR REPLACED WITHIN 4 CALEDARE DAYS.

DETAIL 3 **EROSION CONTROL BLANKET** NOT TO SCALE

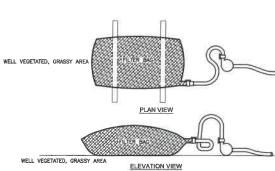


NOTE:
LOW VOLUME FILTER BAGS SHALL BE MADE FROM NON-WOVEN GEOTEXTILE MATERIAL SEWN WITH HIGH STRENGTH
DOUBLE STITCHED "J" TYPE SEAMS. THEY SHALL BE CAPABLE OF TRAPPING PARTICLES LARGER THAN 150 MICRONSHIGH VOLUME STRENGTH FROM WOVEN GEOTEXTILES THAT MEET THE FOLLOWING STANDARDS.

UME	FILTER BAGS SHALL BE MADE FROM	WOVEN GEOTEXTILES	THAT MEET THE FOLLOWIN
	PROPERTY	TEST METHOD	MINIMUM STANDARD
	AVG. WIDE WIDTH STRENGTH	ASTM D-4884	60 LB/IN
	GRAB TENSILE	ASTM D-4632	205 LB
	PUNCTURE	ASTM D-4833	110 LB
	MULLEN BURST	ASTM D-3786	350 PSI
	UV RESISTANCE	ASTM D-4355	70%
	AOS % RETAINED	ASTM D-4751	80 SIÉVE


MEANS OF ACCESSING THE BAG WITH MACHINERY REQUIRED FOR DISPOSAL PURPOSES SHALL BE PROVIDED. S SHALL BE REPLACED WHEN THEY BECOME 'S PLILL OF SEDIMENT, SPARE BAGS SHALL BE KEPT ANALABLE COLBERT OF THOSE THAT HAVE FALLED OR ARE FILLED. BAGS SHALL BE PLACED ON STRAPS TO FACILITATE MLESS BAGS COME WITH LIFTING STRAPS ALREDY ATTACHED.

- BAGS SHALL BE LOCATED IN WELL-VEGETATED (GRASSY) AREA, AND DISCHARGE ONTO STABLE, EROSION RESISTANT AREAS, WHERE THIS IS NOT POSSIBLE, A GEOTEXTILE UNDERKAMENT AND FLOW PATH SHALL BE PROVIDED, BAGS MAY BE PLACED ON FILTER STONE TO MORREAS DISCHARGE CAPACITY. BAGS SHALL NOT BE PLACED ON SLOPES GREATER THAN 5%. FOR SLOPES DECEEDING 5%, CLEAN ROCK OF OTHER NON-ERODIBLE AND NON-POLLITING MATERIAL MAY BE PLACED UNDER THE 18M TO REDUCE SLOPE STEEPINESS.
- THE PUMP DISCHARGE HOSE SHALL BE INSERTED INTO THE BAGS IN THE MANNER SPECIFIED BY THE MANUFACTURER AND SECURELY CLAMPED, A PIECE OF PVC PIPE IS RECOMMENDED FOR THIS PURPOSE.
- THE PUMPING RATE SHALL BE NO GREATER THAN 750 GPM OR 1/4 THE MAXIMUM SPECIFIED BY THE MANUFACTURER, WHICHEVER IS LESS, PUMP INTAKES SHALL BE FLOATING AND SCREENED.

DETAIL 4 **PUMPED WATER FILTER BAG**

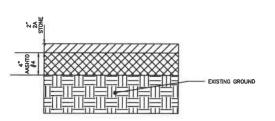

TYPICAL GRAVEL SECTION

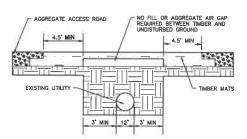


ESS.

NO FILL MATERIAL TO BE PLACED UNDER TOP TIMBER MAT, AIR GAP REQUIRED.

TIMBER MAT TO BE SIZED APPROPRIATELY FOR ANTICIPATED LOAD.

DETAIL 6 TIMBER MAT AIR BRIDGE

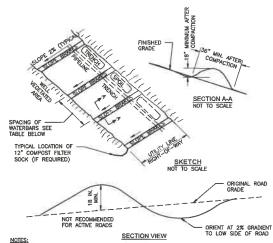


WATERBARS SHALL DISCHARGE TO A STABLE AREA.

WATERBARS SHALL BE INSPECTED WEEKLY (DAILY ON ACTIVE ROADS) AND AFTER EACH RUNOFF EVENT. DAMAGED OR ERODED WATERBARS SHALL BE RESTORED TO ORIGINAL DIMENSIONS WITHIN 24 HOURS OF INSPECTION.

MAINTENANCE OF WATERBARS SHALL BE PROVIDED UNTIL ROADWAY, SKIDTRAIL, OR RIGHT-OF-WAY HAS ACHIEVED PERMANENT STABILIZATION. WATERBARS ON RETIRED ROADWAYS, SKIDTRAILS, AND RIGHT-OF-WAYS SHALL BE LEFT IN PLACE AFTER PERMANENT STABILIZATION HAS BEEN ACHIEVED. SEE TABLE BELOW FOR WATERBAR SPACING.

MAXIMUM WATERBA	AR SPACING TABLE
PERCENT SLOPE	SPACING (FT)
< 5	250
5 - 15	150
15 - 30	100
> 30	EO

DETAIL 7 TYPICAL WATERBAR INSTALLATION NOT TO SCALE

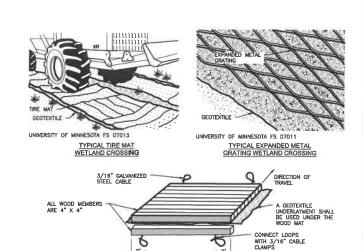

WETLAND CROSSINGS ARE AVOIDED WHEREVER POSSIBLE, WHERE THAT IS NOT POSSIBLE, THE LOCATION OF THE CROSSING AND ITS ORIENTATION ARE SELECTED SO AS TO HAVE THE LEAST POSSIBLE IMPACT UPON THE WETLAND.

TYPICAL WOOD MAT FOR WETLAND CROSSING

- TEMPORARY CROSSINGS SHOULD BE CONSTRUCTED FROM MATERIALS THAT CAN BE PLACED WITH A MINIMUM OI DISTURBANCE TO THE SOIL SURFACE AND COMPLETELY REMOVED WHEN NO LONGER NEEDED. SOME EXAMPLES OF STABILIZED CROSSING METHODS ARE ILLUSTRATED ABOVE.

WETLAND CROSSING STABILIZATION



ON AND SEDIMENTATION CONTROL DETAILS L53 / L55 WELL PLUG EROSI

> DRAWING NUMBER

SHEET 06 OF 14

-	TABLE 3.11.1 F	PERMANENT SEE	DING
SEED MIX	PLANT	NAMES	APPLICATION RATE LBS/ACRE
A	KENTUCKY 31 FESCUE RED FESCUE BIRDSFOOT TREFOIL	FESTUCA ARUNDINACEA FESTUCA RUBRA LOTUS CORNICULATUS	65 20 5
В	SWITCHGRASS PERENNIAL RYEGRASS REDTOP BIRDSFOOT TREFOIL	PANICUM VIRGATUM LOLIUM PERENNE AGROSTIS ALBA LOTUS CORNICULATUS	15 20 5 15
С	RED FESCUE KENTUCKY BLUEGRASS MERION BLUEGRASS	FESTUCA RUBRA POA PRATENSIS POA PRATENSIS	20 40 30
D	KENTUCKY 31 FESCUE RED FESCUE KENTUCKY BLUEGRASS WHITE DUTCH CLOVER	FESTUCA ARUNDINACEA FESTUCA RUBRA POA PRATENSIS TRIFOLIUM REPENS	45 20 25 5
E	PERENNIAL RYEGRASS SWITCHGRASS CROWNVETCH OR	TRIFOLIUM REPENS LOLIUM PERENNE PANICUM VIRGATUM CORONILLA VARIA LATHYRUS LATIFOLIUS	30 15 20
F	OPCHAPDOPASS	DACTYLIS GLOMERATA TRIFOLIUM REPENS AGROSTIS ALBA	30 20 5
G	LADINO CLOVER REDTOP BIRDSFOOT TREFOIL WEEPING LOVEGRASS PERENNIAL RYEGRASS	AGROSTIS ALBA LOTUS CORNICULATUS ERAGROSTIS CURVULA	15 45
н	CROWNVETCH	LOLIUM PERENNE CORONILLA VARIA DACTYLIS GLOMERATE	10 25 40
1	ORCHARDGRASS CROWNVETCH PERENNIAL RYEGRASS	CORONILLA VARIA LOLIUM PERENNE	25 30
J	PERENNIAL PEA ORCHARDGRASS	LATHYRUS LATIFOLIUS DACTYLIS GLOMERATA	30 30
ĸ	DEERTONGUE BIRDSFOOT TREFOIL WEEPING LOVERGRASS	PANICUM CLANDESTINUM LOTUS CORNICULATUS ERAGROSTIS CURVULA	30 15 5
L	ORCHARDGRASS SERECIA LESPEDEZA LADINO CLOVER	DACTYLIT GLOMERATA LESPEDEZA CUNATA TRIFOLIUM REPENS	30 40 5
М	PERENNIAL RYEGRASS LADINO CLOVER REDTOP	LOUIUM PERENNE TRIFOLIUM REPENS AGROSTIS ALBA	50 5 5
N	CROWNVETCH ORCHARDGRASS REDTOP	CORONILLA VARIA DACTYLIS GLOMERATA AGROSTIS ALBA	15 30 5
0	PERENNIAL RYEGRASS BIRDSFOOT TREFOIL REDTOP	LOLIUM PERENNE LOTUS CORNICULATUS AGROSTIS ALBA	40 15 5
Р	SERECIA LESPEDEZA ORCHARDGRASS REDTOP	LESPEDEZA CUNATA DACTYLIS GLOMERATA AGROSTIS ALBA	40 30 5
Q	ORCHARDGRASS REED CANARYGRASS' REDTOP LADINO CLOVER	DACTYLIS GLOMERATA PHALARIS ARUNDINACEA AGROSTIS ALBA TRIFOLIUM REPENS	25 30 5 5
R	KENTUCKY BLUEGRASS REDTOP WHITE CLOVER OR BIRDSFOOT TREFOIL	POA PRATENSIS AGROSTIS ALBA TRIFOLIUM REPENS LOTUS CORNICULATUS	30 5 5 15
s	REED CANARYGRASS' WEEPING LOVERGRASS	PHALARIS ARUNDINACEA ERAGROSTIS CURVULA	40 5
Ť	PERENNIAL RYEGRASS REED CANARYGRASS' BIRDSFOOT TREFOIL	LOLIUM PERENNE PHALARIS ARUNDINACEA LOTUS CORNICULATUS	30 15 5
U	TIMOTHY ALFALFA	PHLUEM PRATENSE MEDICAGO SSATIVA	10 18
v w	TIMOTHY BIRDSFOOT TREFOIL REDTOP	PHLUEM PRATENSE LOTUS CORNICULATUS	10 15
	PERENNIAL RYEGRASS ORCHARDGRASS	AGROSTIS ALBA LOLIUM PERENNE DACTYLIS GLOMERATA	30 25 30
^	BIRDSFOOT TREFOIL REDTOP	PHALARIS ARUNDINACEA LOTUS CORNICULATUS AGROSTIS ALBA	20 5
Y	SWITCHGRASS BIRDSFOOT TREFOIL	PANICUM VIRGATUM LOTUS CORNICULATUS	30 20
Z 1 -	SWITCHGRASS SERECIA LESPEDEZA	PANICUM VIRGATUM LESPEDEZA CUNATA DACTYLIS GLOMERATA	15 30 30
1	ORCHARDGRASS RED CLOVER	TRIFOLIUM PRATENSE	10
A - 2	SWITCHGRASS BIG BLUESTEM INDIANGRASS LITTLE BLUESTEM SIDEOATS GRAMA ²	PANICUM VIRGATUM ANDROPOGON GERARDI SORGHASTRUM NUTANS ANDROPOGON SCOPARIUS BOUTELOUA CURTIPENDULA	15 5 5 5 5
A	SWITCHGRASS	PANICUM VIRGATUM	20

A — SWITCHGRASS PANICUM WRGATUM 15 DATE OF 16 PANICUM WRGATUM 15 DATE OF 15 DATE OF 15 DATE OF 16 PANICUM WRGATUM 15 DATE OF 15 DATE OF 16 DATE

COVER	RATES	(MIN.):	
TYPE	PER ACRE	PER 1,000 SQ. FT.	LIME/FERTILIZER TYPE
LIME	2 TONS	90 LBS	AGRICULTURAL GRADE ONLY
GRASSES AND LEGUMES	1,000 LBS	23 LBS	10-20-10 OR EQUIVALENT
LEGUME STANDS ONLY	1,000 LBS	23 LBS	5-20-10 PREFERRED; 10-20-10 ACCEPTABLE
GRASS STANDS ONLY	1,000 LBS	23 LBS	10-20-10 OR EQUIVALENT

TEMPORARY SEED CHART

	RATES (MIN.):	
MULCHES	PER ACRE	PER 1,000 SQ. FT.	NOTES
STRAW OR HAY	1.5 - 2 TONS (MINIMUM 2 TONS FOR WINTER COVER) 70 - 90 LBS.		FREE FROM WEEDS AND COARSE MATTER. MUST BE ANCHORED. SPREAD WITH MULCH BLOWER OR BY HAND.
FIBER MULCH	R MULCH MINIMUM 1,500 LBS.		DO NOT USE AS MULCH FOR WINTER COVER OR DURING HOT, DRY PERIODS. * APPLY AS SLURRY.
CORNSTALKS	4 6 TONS	185 - 275 LBS.	CUT OR SHREDDED IN 4 - 6 LENGTHS. AIR-DRIED, DO NOT USE IN FINE TURF AREAS, APPLY WITH MULCH BLOWER OR BY HAND.
WOOD CHIPS	4 - 6 TONS	185 – 275 LBS.	FREE OF COARSE MATTER. AIRDRIED. TREAT WITH 12 LBS. NITROGEN PER TON. DO NOT USE IN FINE TURF ARES. APPLY WITH MULCH BLOWER, CHIP HANDLER, OR BY HAND.
BARK CHIPS OR SHREDDED BARK	50 - 70 CU. YDS.	1 - 2 CU. YDS.	FREE OF COARSE MATTER. AIRDRIED. DO NOT USE IN FINE TURF AREAS, APPLY WITH MULCH BLOWER, CHIP HANDLER, OR BY HAND.

PLANT	NAMES	PLANTING DATES	IN DATE				TA	BLE 3	3.11.3	PERMA	NENT	SEEDING	G REQUIR	REMEN	TS							
COMMON	SCIENTIFIC	2/16 -	LBS/ACRE	SEED	FINE	COARSE	LOW	NO	PASTUR	SENSITIVE NATURAL	PH		SHADE	PRE	FERRED PL	ANTING D	ATES					
ANNUAL RYEGRASS	LOLIUM MULTIFLORUM	5/15 8/1 - 11/1	40	Mix	N	LAWN	MAINT.	MAINT.	Ε	AREAS	RANGE	DRAINAGE	TOLERANCE	3/1 - 6/15	6/16 - 8/14	8/15 - 9/15	9/16 2/28					
		3/1 -		A			X 1				6.0 - 7.5	MODWELL	FULL SUN	х	N	х	N					
FIELD BROMEGRASS	BROMUS CILIATUS	6/15 8/1 - 9/15	40	В				х			5.0 - 7.5	MODWELL	FULL SUN	×	N	×	N					
SPRING OATS	AVENA SATIVA	3/1 - 6/15	100	C	X 1	X 1					6.0 - 7.5 6.0 -	MODWELL	FULL SUN	X		X						
WINTER RYE	SECALE CEREALE	8/15 - 2/28	170	E	-	- ·		X 1			7.5 6.0 - 7.5	MODWELL	FULL SUN	×	N	X	N					
WINTER WHEAT	TRITICUM AESTIVUM	8/15 - 2/28	180	F			х	×	х		5.5 - 7.5	MODWELL	TOLERANT	х	N	×	N					
JAPANESE MILLET	ECHINOCHLOA CRUSGALLI	5/15 - 8/15	30	G				х	х		5.0 - 7.5	MODWELL	FULL SUN	х	N	х	N					
REDTOP	AGROSTIS ALBA	3/1 - 6/15	10	н			х	X 1	х		5.0 - 7.5	MODWELL	TOLERANT	×	N	x	N					
ANNUAL RYEGRASS	LOLIUM	3/1 -	30	1			х	X 1	х		5.0 - 7.5	MODWELL	FULL SUN	×	N	×	N					
AND SPRING OATS	AVENA SATIVA	6/15	70	J			х	X 1	X		4.0 - 8.0 4.0 -	MODWELL	TOLERANT	х	N	х	N					
GERMAN/FOX TAIL MILLET	SETARIA ITALICA	5/1 - 8/1	40	K				х	_		7.0	MODWELL	FULL SUN	X	N	х	N					
HAIRY VETCH	VICIA VILLOSA	8/15 - 4/1	60	L M			x	х	x		7.5 5.0 -	MODWELL	TOLERANT	x	N N	x	N					
TARLE	3.11.2 N	IRSE C	ROPS	N			x	X 1	x		7.5 5.0 - 7.5	MODWELL	TOLERANT	×	N	×	N					
				0			х	х	х		5.0 - 7.5	MODWELL	FULL SUN	×	N	х	N					
PLANT		PLANTIN G DATES	PLANTIN	PLANTIN	PLANTIN	PLANTIN	PLANTIN	APPLICATION RATE LBS/ACRE	Р			х	х	х		4.5 - 7.5	MODWELL	TOLERANT	х	N	х	N
COMMON	SCIENTIFIC		LDO) NOIL	Q			х	х	х		4.5 - 7.5	POOR WELL	TOLERANT	х	N	х	N					
ANNUAL RYEGRASS	LOLIUM MULTIFLORUM	2/16 - 5/15 8/1 -	25	R			х	х	х		5.5 - 7.5	MOD WELL	FULL SUN	×	N	х	N					
		11/1		S			Х	Х	×		4.5 ~ 7.5	POOR WELL	FULL SUN	х	N	х	N					
FIELD BROMEGRASS	BROMUS CILIATUS	6/15 8/1 -	20	Т	_				×		5.5 - 7.5	POOR - WELL	FULL SUN	X	N	х	N					
		9/15		U					х		6.5 - 8.0	MOD WELL	FULL SUN	Х	N	х	N					
SPRING DATS	AVENA SATIVA	3/1 - 6/15	50	٧					х		5.5 - 7.5	POOR WELL	FULL SUN	х	N	х	N					
WINTER RYE	SECALE CEREALE	8/15 - 2/28	85	W			x	×	×		5.0 - 7.5	MOD	TOLERANT	х	N	х	N					
WINTER WHEAT	TRITICUM AESTIVUM	8/15 - 2/28	90	х					х		5.5 - 7.5	POOR - WELL	FULL SUN	×	N	х	N					
JAPANESE MILLET	ECHINOCHLO A CRUSGALLI	5/15 - 8/15	15	Y			X	X	×		5.0 - 7.5	MOD WELL MOD	FULL SUN	х	N	x	N					
REDTOP	AGROSTIS ALBA	3/1 - 6/15	10	Z A-1	-		х	X	x		7.5 4.5 -	MOD	FULL SUN TOLERANT	x	N	x	N					
ANNUAL RYEGRASS AND SPRING	LOLIUM MULTIFLORUM AVENA	3/1 -	15 35	A-2				х	x	х	7.5 5.0 - 7.5	WELL MOD WELL	FULL SUN	×	N	x	N					
OATS	SATIVA	6/15		A3				х		х	5.0 -	POOR - WELL	FULL SUN	х	N	х	N					
GERMAN/FOX TAIL MILLET	SETARIA ITALICA	5/1 - 8/1	25	1 - UI N - N	RBAN	AREAS ON CROPS RE	ILY QUIRED															
HAIRY VETCH	VICIA VILLOSA	8/15 -	30																			

DETAIL 9
TEMPORARY AND PERMANENT SEEDING
MIXTURES, MULCHING, AND FERTILIZER

	RATE (LBS/ACRE)			
SEED:	ERNMX-128 (OR EQUIVALENT) ¹			15
	CAREX VULPINOIDEA	FOX SEDGE	20%	
	ECHINOCHLOA CRUSGALLI VAR. FRUMENTACEA	JAPANESE MILLET	20%	
	EYMUS VIRGINICUS	VIRGINIA WILD RYE	20%	
POLYGONUM PENSYLVANICUM	POLYGONUM PENSYLVANICUM	PENNSYLVANIA SMARTWEED	19.5%	
	AGROSTIS SCABRA	TICKLEGRASS (ROUGH BENTGRASS)	5%	
	PANICUM VIRGATUM, SHELTER	SHELTER SWITCH GRASS	5%	
	CAREX STIPATA	AWL SEDGE	3%	
	PANICUM CLANDESTINUM	TIOGA DEER TONGUE	3%	
	CAREX SCOPARIA	BLUNT BROOM SEDGE	2.5%	
	BIDENS CERNUA MIX	NODDING BUR MARIGOLD MIX	1%	
	JUNCUS TENUIS	PATH RUSH	1%	
MULCH:	STRAW OR HAY		-	6,000

DETAIL 10
VEGETATIVE STABILIZATION - WETLAND MIX





KEYSTONE
CONSULTANTS, LLC
32 EAST MAIN STREET
CARNEGIE. PA, 15 105


EROSION AND SEDIMENTATION CONTROL DETAILS

DRAWING NUMBER


SHEET 07 OF 14

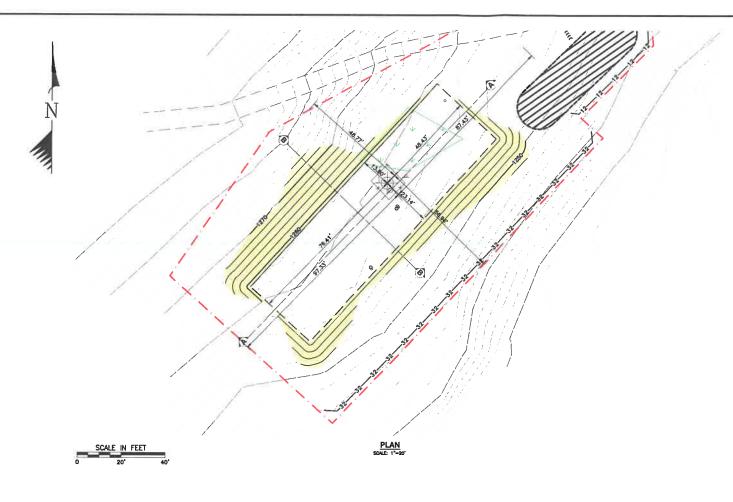

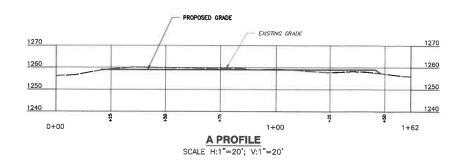


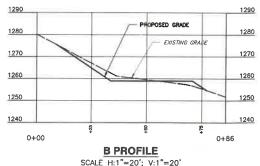

WELL L53 PLAN AND PROFILE

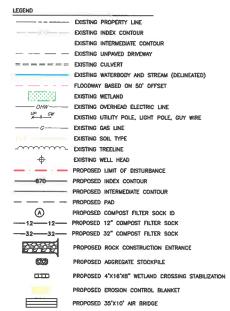

- CONTRACTOR TO PLACE GEO-TEXTILE AND AGGREGATE ON ACCESS ROAD AS NECESARY. SEE DETAIL 5 ON PAGE 903.

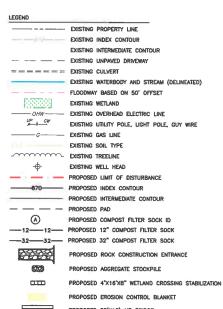

KEYSTONE ON SULTANTS, LLC SZEASTMAN SYREET CARNEGIE, PA 15106

			O		
סבר	STK	EAZ	11/13/2019	1" = 20"	WV83-NF
	OHOHO	CANONICA	DATE	SCALE	SYSTEM


GRADING PLAN


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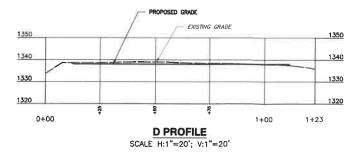
SHEET 08 OF 14

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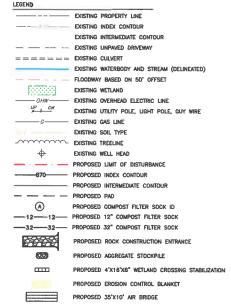
SCALE H:1"=20'; V:1"=20'






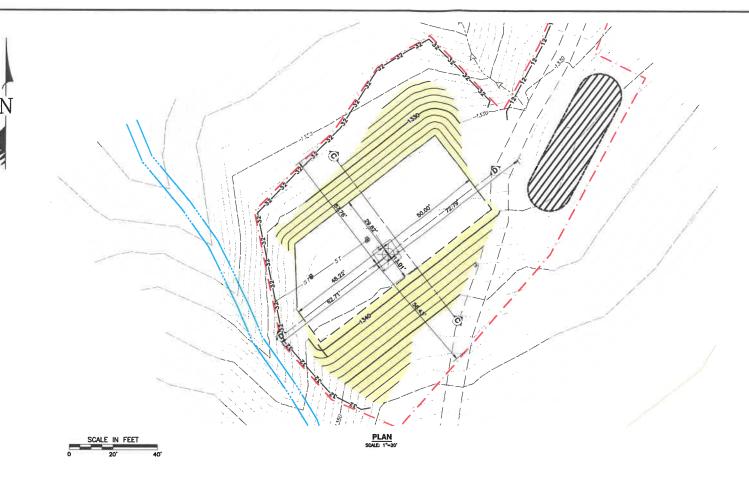

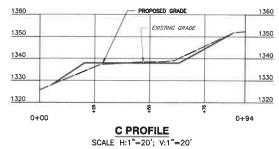WELL L55 PLAN AND PROFILE



- CONTRATOR TO USE EXISTING ACCESS ROAD AND MAINTAIN AS NECESSARY.
- CONTRACTOR TO PLACE GEO—TEXTILE AND AGGREGATE ON ACCESS ROAD AS NECESARY.
 SEE DETAIL 5 ON PAGE 903.

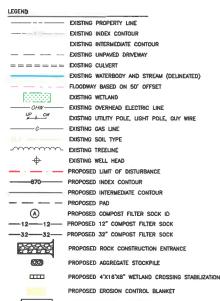

CAX

GRADING PLAN

DRAWING NUMBER

SHEET 09 OF 14



CNX	L55 WELL PLUGGING			
Description	Units	Quantity		
1. Clearing and Grubbing				
A. Cut/Process/Grub	AC	1.10		
2. Erosion and Sediment Controls				
A. 12" Compost Filter Sock	LF	540.00		
B. 32" Compost Filter Sock	LF	270.00		
C. Waterbars	EA	8.00		
D. Timber Mat Alr Bridge	EA	5.00		
E. Wetland Stabilisation Mat	EA	6.00		
3. Aggregate Surface				
A RCE (AASHTO #1) - Install Only	TN	45.00		
B. Geotextile Underlayment	SY	120.00		
4. Grading - Earthwork				
A. Cut	CY	240.00		
B. Fill	CY	240.00		
C. Topsoil to be Removed	Or .	250,00		
5. Finishing				
A. Temporary Seed and Mulch	AC	0.15		
B. Slope Matting	SY	730.00		






L53 / L55 WELL PLUGGING STRICT, MONOGALIA COUNTY, WEST QUANTITIES

DRAWING NUMBER

907 SHEET 10 OF 14

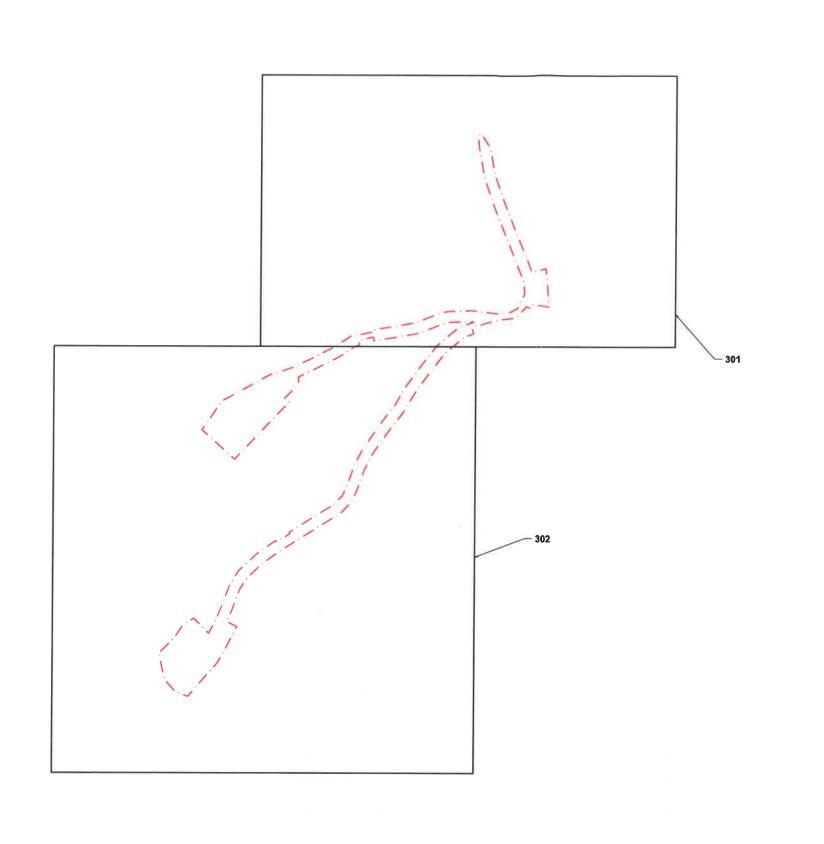



LEGEND			
	EXISTING	PROPERTY LINE	-
	EXISTING	INDEX CONTOUR	
	EXISTING	INTERMEDIATE CONTOUR	
	EXISTING	UNPAVED DRIVEWAY	
=====	EXISTING	CULVERT	
	EXISTING	WATERBODY AND STREAM	(DELINEATED
	AREA TO	BE RESTORED	
	EXISTING	GAS LINE	
	EXISTING	SOIL TYPE	
	EXISTING	TREELINE	
	EXISTING	WETLAND	

		L53
- ILLA		WELL PLUGGING
Description	Units	Quantity
1. Erosion and Sedimentation Control		
A. Erosion and Sedimentation Control BMPs	LS	1.00
2.Grading - Earthwork		
A.Cut	CY	230.00
B.Fill	CY	230.00
C.Topsoil to be Replaced	CY	125.00
3. Finishing		
A. Permanent Seed and Mulch	AC	0.85

CNX		L55 WELL PLUGGING	
Description	Units	Quantity	
1. Erosion and Sedimentation Control			
A Erosion and Sedimentation Control BMPs	15	1.00	
2 Grading - Earthwork			
A Out	CY	240.00	
B.Fil)	CY	240.00	
C. Topsoil to be Replaced	CY	250.00	
3. Finishing			
A. Permanent Seed and Mulch	AC	1.10	







KEYSTONE

Z CONSULTANTS, LLC

SLESS MANUS STREET

CARNEGIE PA 15706

PRIGITAL TO STREET

CARNEGIE PA 15706

PRIGITAL TO STREET


CARNEGIE PA 15706

LS3 / LS5 WELL PLUGGING
LE DISTRICT, MONGGALA COUNTY, WEST VIRGINIA
INDEX SHEET

DRAWING NUMBER

300
SHEET 11 OF 14

PLAN SCALE: 1" = 100"

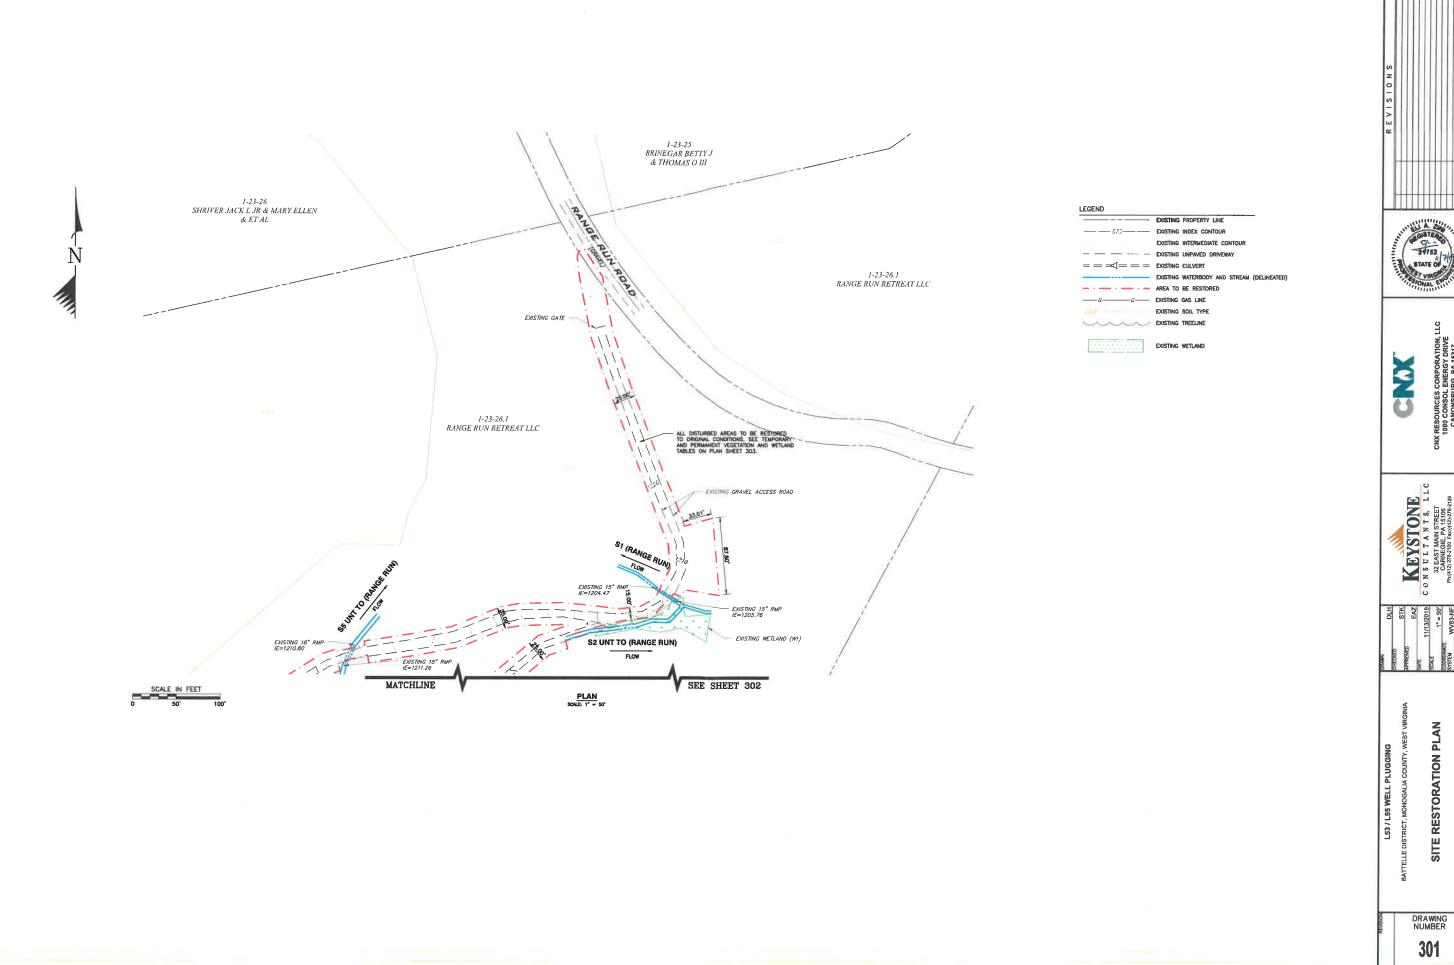





SHEET 12 OF 14

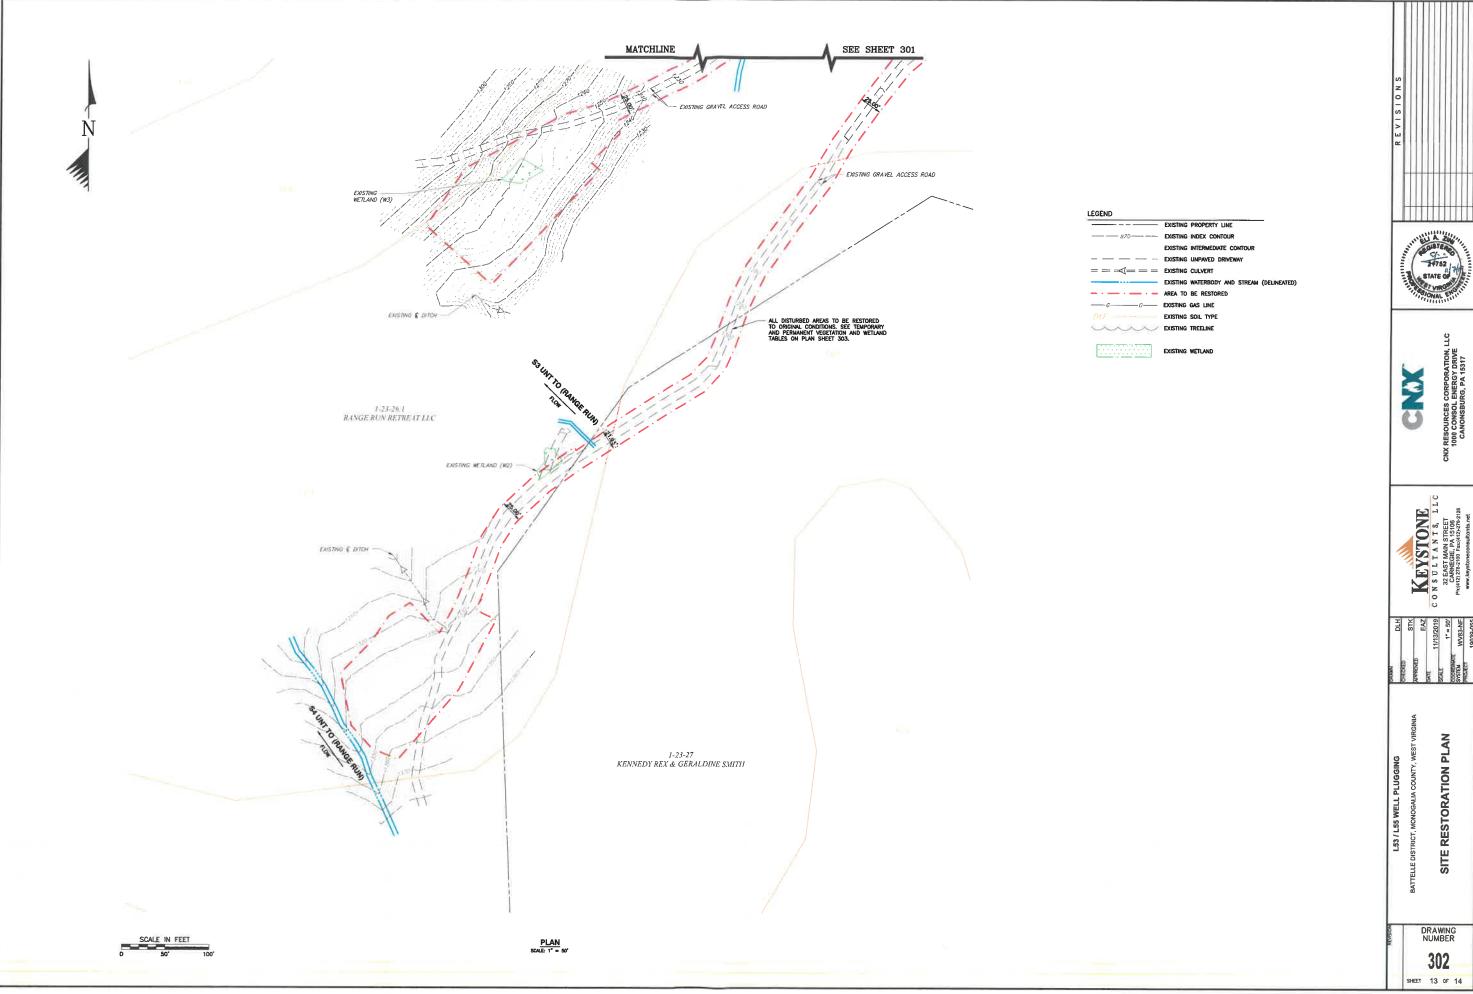








	TABLE 3.11.1 F	PERMANENT SEE	DING		
SEED MIX	PLANT	NAMES	APPLICATI N RATE LBS/ACR		
			LDO, MOR		
A	KENTUCKY 31 FESCUE RED FESCUE BIRDSFOOT TREFOIL	FESTUCA ARUNDINACEA FESTUCA RUBRA LOTUS CORNICULATUS	65 20 5		
B	SWITCHGRASS PERENNIAL RYEGRASS REDTOP BIRDSFOOT TREFOIL	PANICUM VIRGATUM LOLIUM PERENNE AGROSTIS ALBA LOTUS CORNICULATUS	15 20 5 15		
С	RED FESCUE	FESTUCA RUBRA	20		
	RED FESCUE KENTUCKY BLUEGRASS MERION BLUEGRASS	FESTUCA RUBRA POA PRATENSIS POA PRATENSIS	40 30		
D	KENTUCKY 31 FESCUE RED FESCUE KENTUCKY BLUEGRASS WHITE DUTCH CLOVER	FESTUCA ARUNDINACEA FESTUCA RUBRA POA PRATENSIS TRIFOLIUM REPENS	45 20 25 5		
F		TRIFOLIUM REPENS	70		
E	PERENNIAL RYEGRASS SWITCHGRASS CROWNVETCH OR PERENNIAL PEA	LOLIUM PERENNE PANICUM VIRGATUM CORONILLA VARIA LATHYRUS LATIFOLIUS	30 15 20 30		
F	ORCHARDGRASS LADINO CLOVER REDTOP	DACTYLIS GLOMERATA TRIFOLIUM REPENS AGROSTIS ALBA	20 5 5		
G	BIRDSFOOT TREFOIL WEEPING LOVEGRASS PERENNIAL RYEGRASS	LOTUS CORNICULATUS ERAGROSTIS CURVULA LOLIUM PERENNE	15 45 10		
Н	CROWNVETCH ORCHARDGRASS	CORONILLA VARIA DACTYLIS GLOMERATE	25 40		
1	CROWNVETCH PERENNIAL RYEGRASS	CORONILLA VARIA LOLIUM PERENNE	25 30		
J	PERENNIAL PEA ORCHARDGRASS	LATHYRUS LATIFOLIUS DACTYLIS GLOMERATA	30 30		
К	DEERTONGUE BIRDSFOOT TREFOIL WEEPING LOVERGRASS	PANICUM CLANDESTINUM LOTUS CORNICULATUS ERAGROSTIS CURVULA	30 15 5		
L	ORCHARDGRASS SERECIA LESPEDEZA LADINO CLOVER	DACTYLIT GLOMERATA LESPEDEZA CUNATA TRIFOLIUM REPENS	30 40 5		
М	PERENNIAL RYEGRASS LADINO CLOVER REDTOP	LOLIUM PERENNE TRIFOLIUM REPENS AGROSTIS ALBA	50 5 5		
N	CROWNVETCH ORCHARDGRASS REDTOP	CORONILLA VARIA DACTYLIS GLOMERATA AGROSTIS ALBA	15 30 5		
0	PERENNIAL RYEGRASS BIRDSFOOT TREFOIL REDTOP	LOLIUM PERENNE LOTUS CORNICULATUS AGROSTIS ALBA	40 15 5		
Р	SERECIA LESPEDEZA ORCHARDGRASS REDTOP	LESPEDEZA CUNATA DACTYLIS GLOMERATA AGROSTIS ALBA	40 30 5		
Q	ORCHARDGRASS REED CANARYGRASS' REDTOP LADINO CLOVER	DACTYLIS GLOMERATA PHALARIS ARUNDINACEA AGROSTIS ALBA TRIFOLIUM REPENS	25 30 5 5		
R	KENTUCKY BLUEGRASS REDTOP WHITE CLOVER OR BIRDSFOOT TREFOIL	POA PRATENSIS AGROSTIS ALBA TRIFOLIUM REPENS LOTUS CORNICULATUS	30 5 5 15		
S	REED CANARYGRASS' WEEPING LOVERGRASS	PHALARIS ARUNDINACEA ERAGROSTIS CURVULA	40 5		
Т	PERENNIAL RYEGRASS REED CANARYGRASS' BIRDSFOOT TREFOIL	LOLIUM PERENNE PHALARIS ARUNDINACEA LOTUS CORNICULATUS	30 15 5		
U	TIMOTHY ALFALFA	TIMOTHY PHLUEM PRATENSE ALFALFA MEDICAGO SSATIVA			
v	TIMOTHY BIRDSFOOT TREFOIL	PHLUEM PRATENSE LOTUS CORNICULATUS	18 10 15		
w	REDTOP PERENNIAL RYEGRASS ORCHARDGRASS	AGROSTIS ALBA LOLIUM PERENNE DACTYLIS GLOMERATA	5 30 25		
х	REED CANARYGRASS¹ BIRDSFOOT TREFOIL REDTOP	PHALARIS ARUNDINACEA LOTUS CORNICULATUS AGROSTIS ALBA	30 20 5		
Y	SWITCHGRASS BIRDSFOOT TREFOIL	PANICUM VIRGATUM LOTUS CORNICULATUS	30 20		
z	SWITCHGRASS SERECIA LESPEDEZA	PANICUM VIRGATUM	15 30		
1 -	ORCHARDGRASS RED CLOVER	DACTYLIS GLOMERATA	30 10		
2	SWITCHGRASS	PANICUM VIRGATUM	15		
2	SWTCHGRASS BIG BLUESTEM INDIANGRASS LITTLE BLUESTEM SIDEOATS GRAMA ²	PANICUM VIRGATUM ANDROPOGON GERARDI SORGHASTRUM NUTANS ANDROPOGON SCOPARIUS BOUTELOUA CURTIPENDULA	5 5 5		
·	SWITCHGRASS	PANICUM VIRGATUM	20		

A - SWITCHGRASS PANICUM WRGATUM 15 EASTERN GAMAGRASS INTERPSACUM 15 DATE OF APPLICATION CAN BE REDUCED BY 30 PERCENT EXCEPT FOR SEED MIXES A-2 & A-3. WRED CANARYGRASS SHALL NOT BE USED EAST OF I-79 AND/OR SOUTH OF CHARLESTON.

2 USE NORTH AND EAST OF I-64 AND I-79.

COVER TYPE	RATES	(MIN.):	
	PER ACRE PER 1,000 SQ. FT.		LIME/FERTILIZER TYPE
LIME	2 TONS	90 LBS	AGRICULTURAL GRADE ONLY
GRASSES AND LEGUMES	1,000 LBS	23 LBS	10-20-10 OR EQUIVALENT
LEGUME STANDS ONLY	1,000 LBS	23 LBS	5-20-10 PREFERRED; 10-20-10 ACCEPTABLE
GRASS STANDS ONLY	1,000 LBS	23 LBS	10-20-10 OR EQUIVALENT

TEMPORARY SEED CHART

ORGANIC MULCH MATERIALS AND APPLICATION RATES						
MULCHES	RATES (MIN.):				
MOLCHES	PER ACRE	PER 1,000 SQ. FT.	NOTES			
STRAW OR HAY	1.5 - 2 TONS (MINIMUM 2 TONS FOR WINTER COVER)	70 - 90 LBS.	FREE FROM WEEDS AND COARSE MATTER. MUST BE ANCHORED, SPREAD WITH MULCH BLOWER OR BY HAND.			
FIBER MULCH	MINIMUM 1,500 LBS.	35 LBS.	DO NOT USE AS MULCH FOR WINTER COVER OR DURING HOT, DRY PERIODS. * APPLY AS SLURRY.			
CORNSTALKS	4 - 6 TONS	185 - 275 LBS.	CUT OR SHREDDED IN 4 - 6 LENGTHS. AIR-DRIED. DO NOT USE IN FINE TURF AREAS. APPLY WITH MULCH BLOWER OR BY HAND.			
WOOD CHIPS	4 - 6 TONS	185 - 275 LBS.	FREE OF COARSE MATTER. AIRDRIED, TREAT WITH 12 LBS, NITROGEN PER TON, DO NOT USE IN FINE TURF ARES. APPLY WITH MULCH BLOWER, CHIP HANDLER, OR BY HAND.			
BARK CHIPS OR SHREDDED BARK	50 - 70 CU. YDS.		FREE OF COARSE MATTER. AIRDRIED. DO NOT USE IN FINE TURF AREAS. APPLY WITH MULCH BLOWER, CHIP HANDLER, OR BY HAND.			
* WHEN FIBER USED,	MULCH IS THE ONLY APPLY AT A MINIMUM	RATE OF 2,000	DURING PERIODS WHEN STRAW SHOULD BE LBS./AC. OR 45 LBS./1,000 SQ. FT.			

PLANT NAMES		PLANTING DATES	APPLICATIO N RATE	TABLE 3.11.3 PERMANENT SEEDING REQUIREMENTS													
соммон	SCIENTIFIC		LBS/ACRE	SEED	FINE	COARSE	LOW	NO	PASTUR	SENSITIVE	PH		SHADE	PRE	FERRED PI	LANTING D	ATES
ANNUAL LOLIUM RYEGRASS MULTIFLORUM	2/16 - 5/15 8/1 - 11/1	40	MIX	LAW N	LAWN	MAINT.	MAINT.	E	NATURAL AREAS	RANGE	DRAINAGE	TOLERANCE	3/1 - 6/15	6/16 - 8/14	8/15 - 9/15	9/16 - 2/28	
	3/1 -		A			X 1				6.0 - 7.5	MODWELL	FULL SUN	х	N	х	N	
FIELD BROMEGRASS	BROMUS	6/15 8/1 - 9/15	40	В				х			5.0 - 7.5 6.0 -	MODWELL	FULL SUN	х	N	х	N
SPRING OATS	AVENA SATIVA	3/1 - 6/15	100	C	X 1						7.5	MOD.~WELL	FULL SUN	X		×	-
WINTER RYE	SECALE CEREALE	8/15 -	170	E		X 1	_	X 1			7.5 6.0 -	MODWELL	FULL SUN	x	N	x	N
WINTER WHEAT	TRITICUM AESTIVUM	8/15 - 2/28	180	F			х	х.	x		7.5 5.5 -	MODWELL	TOLERANT	×	N	x	N
JAPANESE MILLET	ECHINOCHLOA	5/15 - 8/15	30	G			_	x	х		7.5 5.0 - 7.5	MODWELL	FULL SUN	×	N	х	N
REDTOP	AGROSTIS	3/1 -	10	н			х	X 1	х		5.0 - 7.5	MODWELL	TOLERANT	х	N	х	N
ANNUAL	LOLIUM	6/15		T			x	X 1	х		5.0 ~	MODWELL	FULL SUN	х	N	х	N
RYEGRASS AND SPRING OATS	MULTIFLORUM AVENA SATIVA	3/1 - 6/15	30 70	J			х	X 1	х		4.0 - 8.0	MODWELL	TOLERANT	x	N	х	N
GERMAN/FOX TAIL MILLET	SETARIA ITALICA	5/1 - 8/1	40	к				х			4.0 - 7.0	MODWELL	FULL SUN	×	N	х	N
HAIRY VETCH	VICIA	8/15 -	60	L			×				4.5 - 7.5	MODWELL	TOLERANT	х	N	х	N
	VILLOSA	4/1		М			x	х	×		5.0 - 7.5	MODWELL	TOLERANT	х	N	х	N
TABLE	3.11.2 N	URSE C	ROPS	N			x	X 1	x		5.0 - 7.5	MODWELL	TOLERANT	x	N	х	N
PLANT	NAMES		APPLICATION	0			х	×	x		5.0 - 7.5	MODWELL	FULL SUN	x	N	х	N
COMMON	SCIENTIFIC	PLANTIN G DATES	RATE LBS/ACRE	P			х	х	х		4.5 - 7.5	MODWELL	TOLERANT	X	N	х	N
Common	SOLKIIITO	2/16 -		Q			х	×	х		4.5 - 7.5 5.5 -	POOR - WELL MOD	TOLERANT	X	N	Х	N
ANNUAL LOLIUM RYEGRASS MULTIFLORO	LOLIUM MULTIFLORUM		25	R	-		Х	X	×		7.5 4.5 -	WELL.	FULL SUN	Х	N	х	N
		3/1 -		S	\dashv		X	Х	X	_	7.5	WELL POOR -	FULL SUN	×	N	Х	N
FIELD BROMEGRASS	BROMUS CILIATUS	6/15 8/1 -	20	U	\dashv		_		x	_	7.5 6.5 -	WELL MOD. —	FULL SUN	X	N	X	N
SPRING OATS	AVENA	9/15	50	V	-	-	_	-	×		8.0 5.5 -	POOR -	FULL SUN	x	N	x	N
WINTER RYE	SATIVA SECALE	6/15 8/15 -	85	w			x	x	×		7.5 5.0 -	WELL.	TOLERANT	×	N	×	N
WINTER	TRITICUM	2/28 8/15 -		x	\neg			-	×		7.5 5.5 -	POOR -	FULL SUN	x	N	x	N
WHEAT JAPANESE	AESTIVUM ECHINOCHLO	2/2B 5/15 -	90	Y			х	х	х		7.5 5.0 - 7.5	WELL WOD WELL	FULL SUN	х	N	x	N
MILLET	A CRUSGALLI	8/15	15	z			х	×	×		5.0 - 7.5	MOD WELL	FULL SUN	х	N	x	N
REDTOP	AGROSTIS ALBA	3/1 - 6/15	10	A-1					×		4.5 - 7.5	MOD WELL	TOLERANT	×	N	×	N
ANNUAL RYEGRASS AND SPRING	LOLIUM MULTIFLORUM AVENA	3/1 - 6/15	15 35	A-2				х	х	^	5.0 - 7.5	MOD WELL	FULL SUN	х	N	_ X	N
OATS GERMAN/FOX	SATIVA SETARIA	5/1 -	25	A-3	DD4::	DEAE A		х		х	5.0 - 7.5	POOR - WELL	FULL SUN	х	N	х	N
TAIL MILLET	VICIA	8/1 -	30			REAS ON											

DETAIL 1
TEMPORARY AND PERMANENT SEEDING
MIXTURES, MULCHING, AND FERTILIZER

	VEGETATIVE	STABILIZATION - WETLAND MIX					
	RATE (LBS/ACRE)						
SEED:	ERNMX-128 (OR EQUIVALENT)1	1:					
	CAREX VULPINOIDEA	FOX SEDGE					
	ECHINOCHLOA CRUSGALLI VAR. FRUMENTACEA	JAPANESE MILLET	20%				
	EYMUS VIRGINICUS	VIRGINIA WILD RYE	20% 19,5%				
	POLYGONUM PENSYLVANICUM	PENNSYLVANIA SMARTWEED					
	AGROSTIS SCABRA	TICKLEGRASS (ROUGH BENTGRASS)	5%				
	PANICUM VIRGATUM, SHELTER	SHELTER SWITCH GRASS	5%				
	CAREX STIPATA	AWL SEDGE	3%				
	PANICUM CLANDESTINUM	TIOGA DEER TONGUE	2.5%				
	CAREX SCOPARIA	BLUNT BROOM SEDGE					
	BIDENS CERNUA MIX	NODDING BUR MARIGOLD MIX	1%				
	JUNCUS TENUIS	PATH RUSH	1%				
WULCH:	ULCH: STRAW OR HAY						

<u>DETAIL 2</u> <u>VEGETATIVE STABILIZATION - WETLAND MIX</u>





KEYSTONE
CONSULTANTS, LLC
32 EAST MAIN STREET
ACCORDING CONTRACT
ACCORDING
ACCORDING CONTRACT
ACCORDING CONT

SITE RESTORATION PLAN DETAILS

DRAWING NUMBER

303